GENERAL NOTES

- 1. USE FIGURED DIMENSIONS. DO NOT SCALE FROM THE DRAWINGS. CONFIRM ALL DIMENSIONS ON SITE PRIOR TO CONSTRUCTION OR FABRICATION. IT REMAINS THE CONTRACTORS RESPONSIBILITY TO ENSURE COMPLIANCE WITH ALL RELEVANT CODES AND REGULATIONS IS MAINTAINED AT ALL TIMES
- 2. FIGURED DIMENSIONS TAKE PRECEDENCE, DO NOT SCALE FROM DRAWINGS.
- 3. ALL CONSTRUCTION SHALL CONFORM TO THE NATIONAL CONSTRUCTION CODE (NCC) AND ALL OTHER RELEVANT CODES AND AUSTRALIAN STANDARDS.
- 4. ALL MATERIALS TO BE NEW UNLESS SPECIFIED OTHERWISE.
- 5. REFER TO ENGINEERS DRAWINGS FOR DESIGN OF WIND LOADING, BRACING AND FRAMING DETAILS.
- 6. STEEL WORK TO BE IN ACCORDANCE WITH ENGINEERS DETAILS AND SPECIFICATIONS AND RELEVANT AUSTRALIAN STANDARDS.
- 7. EXTENT OF CONTRACTOR'S AREA SITE BOUNDARY OR AS AGREED WITH OWNER.
- 8. WHERE AN ITEM IS NOTED, IT IS ASSUMED THE BUILDER SHALL ALLOW FOR ITS CONNECTION TO THE BUILDING SYSTEMS, REGARDLESS IF SHOWN OTHERWISE ON CONSULTANT DRAWINGS (I.E. A FIELD INLET SHOWN IS TO BE CONNECTED TO THE SW SYSTEM).
- 9. THE BUILDER ACCEPTS TO SUPPLY AND INSTALL ALL ITEMS NOTED ON THE ARCHITECTURAL & CONSULTANT DRAWINGS. NOT ALL TRADE SPECIFIC DETAIL MAY BE SPECIFIED IN THE ONE PARTICULAR CONSULTANT DOCUMENTS & MAY BE SPREAD OVER SEVERAL DRAWINGS.

WHS


- 1. THESE NOTES MUST BE READ AND UNDERSTOOD BY ALL INVOLVED IN THE PROJECT. THIS INCLUDES (BUT IS NOT EXCLUDED TO): OWNER, BUILDER, SUB-CONTRACTORS, CONSULTANTS, RENOVATORS, OPERATORS, MAINTAINERS, DEMOLISHERS.
- 2. WORKPLACE HEALTH AND SAFETY MATTERS AND CONDITION OF THE SITE ARE IN THE FIRST INSTANCE THE RESPONSIBILITY OF THE PRINCIPAL CONTRACTOR.

TENDERING

- 1. CONTRACTORS SHALL VISIT THE SITE PRIOR TO TENDERING TO FAMILIARISE THEMSELVES WITH ACCESS AND SITE CONDITIONS. FAILURE TO DO SO WILL NOT BE GROUNDS FOR A CLAIM FOR ITEMS WHICH AN INSPECTION WOULD HAVE DISCLOSED.
- 2. REPORT ANY DISCREPANCIES (ON DRAWING OR ON-SITE) TO THE DESIGNER BEFORE COMMENCING OR CONTINUING CONSTRUCTION.

ENERGY EFFICIENCY

1. ENERGY EFFICIENCY REPORT REQUIREMENTS OF THIS DEVELOPMENT MUST BE CARRIED OUT AS PART OF THE PROPOSED DEVELOPMENT TO COMPLY WITH THE QDC 4.1 AND THE BCA 3.12 A FORM 16 - ASPECT CERTIFICATE TO CONFIRM COMPLIANCE WITH THE ENERGY REPORT.

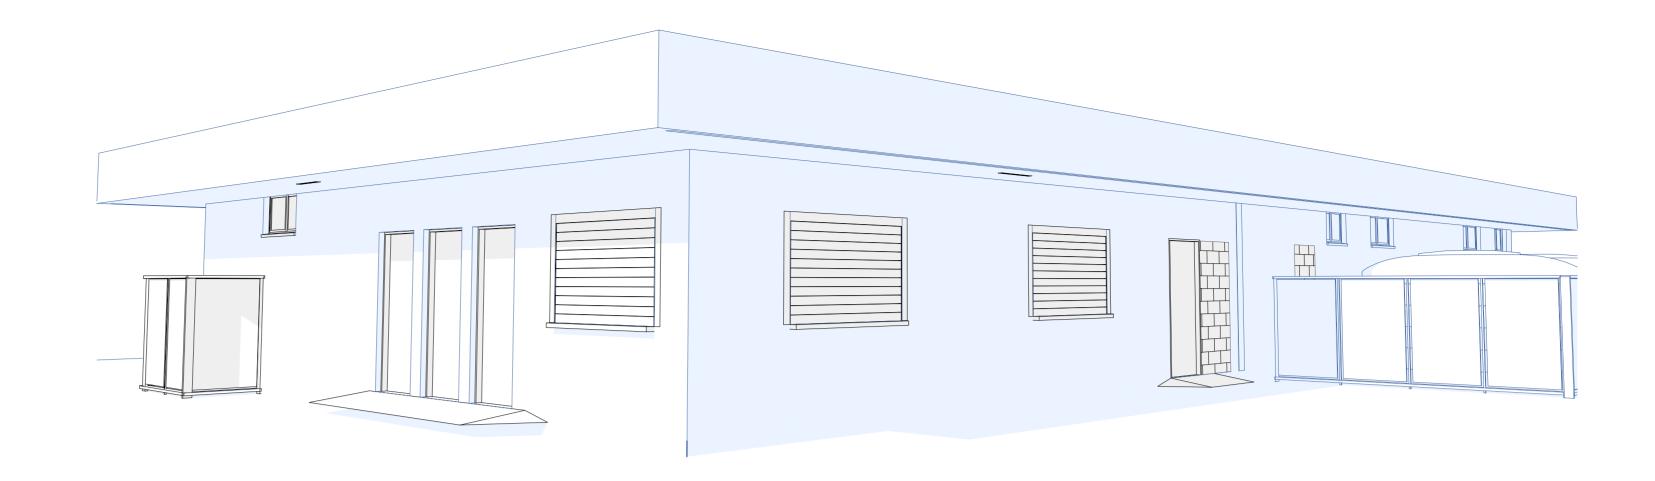

PERSPECTIVE VIEW

DRAWING LIST						
Drawing No:	Description	Issue				
BA/01	Cover Sheet	Α				
BA/02	WHS	Α				
BA/03	Location Plan	Α				
BA/04	SITE PLAN	Α				
BA/05	EXISTING & DEMOLIT	Α				
BA/06	Proposed Ground Floor	Α				
BA/07	Typical Section 1/2	Α				
BA/08	Ceiling Plan	Α				
BA/09	Roof Plan	Α				
BA/10	Exterior Elevations	Α				
BA/11	Kitchen Int Elevations	Α				
BA/12	Canteen Internal Elevat	Α				
BA/13	CHANGE ROOMS	Α				
BA/14	Electrical Layouts	Α				

	S 6 SPORTS BUILDING ASSESSABLE	
	<u>L AUTHORITY</u> aa Shire Council	
	CTURAL ENGINEERING eering (TBA)	
SOIL N/A	CLASSIFICATION	
ENEF N/A	GY EFFICIENCY	
Cons	TRICAL & MECHANICAL ENGINEE Ilting Engineers (TBA) Anderson Consulting Electrical	R
	AUALIC ENGINEER Ilting Engineers - D & C	
	DING CERTIFICATION na Shire Council	
	KPLACE HEALTH & SAFETY R DRAWINGS BA02	

PROPOSED
REFURBISHMENTS
SPORTS CLUB

RAINBOW BILOLEA
QLD 4715

for

Banana Shire
Council

The builder shall check and verify all all dimensions on site

Not to be used for construction, until issued as such.

IF IN DOUBT CHECK

REV ID	Transmittal Set	DESCRIPTION
Α	21/08/2024	TENDER

Mailing Address 262 Grubb St Koongal QLD 4701 e: andrew@amfbuildingdesign.com.au m 0423 375 400

OBCC No 1068756
ABN 22143 527 198
all projects
residential,commercial,industrial



Client
Banana Shire Council
Project Name
PROPOSED REFURBISHMENTS SPORTS CLUB
RAINBOW
BILOLEA QLD 4715

Building Plans
Cover Sheet

Scale: As shown

Status: CD

Checked By:

Project No: Drawing No.:

AMF 24584

BA/01

1. FALLS, SLIPS, TRIPS

a) WORKING AT HEIGHTS

DURING CONSTRUCTION

Wherever possible, components for this building should be prefabricated off-site or at ground level to minimise the risk of workers falling more than two metres. However, construction of this building will require workers to be working at heights where a fall in excess of two metres is possible and injury is likely to result from such a fall. The builder should provide a suitable barrier wherever a person is required to work in a situation where falling more than two metres is a possibility.

DURING OPERATION OR MAINTENANCE

Cleaning and maintenance of windows, walls, roof or other components of this building will require persons to be situated where a fall from a height in excess of two metres is possible. Where this type of activity is required, scaffolding, ladders or trestles should be used in accordance with relevant codes of practice, regulations or legislation.

Anchorage points for portable scaffold or fall arrest devices have been included in the design for use by maintenance workers. Any persons engaged to work on the building after completion of construction work should be informed about the anchorage points.

b) SLIPPERY OR UNEVEN SURFACES

FLOOR FINISHES

The owner is responsible for the selection of surface finishes in the pedestrian trafficable areas of this building. Surfaces should be selected in accordance with AS HB 197:1999 and AS/NZ 4586:2004. STEPS, LOOSE OBJECTS AND UNEVEN SURFACES

Due to design restrictions for this building, steps and/or ramps are included in the building which may be a hazard to workers carrying objects or otherwise occupied. Steps should be clearly marked with both visual and tactile warning during construction, maintenance, demolition and at all times when the building operates as a workplace.

Building owners and occupiers should monitor the pedestrian access ways and in particular access to areas where maintenance is routinely carried out to ensure that surfaces have not moved or cracked so that they become uneven and present a trip hazard. Spills, loose material, stray objects or any other matter that may cause a slip or trip hazard should be cleaned or removed from access ways.

Contractors should be required to maintain a tidy work site during construction, maintenance or demolition to reduce the risk of trips and falls in the workplace. Materials for construction or maintenance should be stored in designated areas away from access ways and work areas.

2. FALLING OBJECTS

LOOSE MATERIALS OR SMALL OBJECTS

Construction, maintenance or demolition work on or around this building is likely to involve persons working above ground level or above floor levels. Where this occurs one or more of the following measures should be taken to avoid objects falling from the area where the work is being carried out onto persons below.

- 1. Prevent or restrict access to areas below where the work is being carried out.
- 2. Provide toeboards to scaffolding or work platforms.
- 3. Provide protective structure below the work area.
- 4. Ensure that all persons below the work area have Personal Protective Equipment.

BUILDING COMPONENTS

During construction, renovation or demolition of this building, parts of the structure including fabricated steelwork, heavy panels and many other components will remain standing prior to or after supporting parts are in place. Contractors should ensure that temporary bracing or other required support is in place at all times when collapse which may injure persons in the area is a possibility.

Mechanical lifting of materials and components during construction, maintenance or demolition presents a risk of falling objects. Contractors should ensure that appropriate lifting devices are used, that loads are properly secured and that access to areas below the load is prevented or restricted.

3. TRAFFIC MANAGEMENT

Parking of vehicles or loading/unloading of vehicles on this roadway may cause a traffic hazard. During construction, maintenance or demolition of this building designated parking for workers and loading areas should be provided. Trained traffic management personnel should be responsible for the supervision of these areas.

Construction of this building will require loading and unloading of materials on the roadway. Deliveries should be well planned to avoid congestion of loading areas and trained traffic management personnel should be used to supervise loading/unloading areas. Busy construction and demolition sites present a risk of collision where deliveries and other traffic are moving within the site. A traffic management plan supervised by trained traffic management personnel should be adopted for the work site.

4. SERVICES

Rupture of services during excavation or other activity creates a variety of risks including release of hazardous material. Existing services are located on or around this site. Where known, these are identified on the plans but the exact location and extent of services may vary from that indicated. Services should be located using an appropriate service (such as Dial Before You Dig), appropriate excavation practice should be used and, where necessary, specialist contractors should be used. Underground power lines are located in or around this site. All underground power lines must be disconnected or carefully located and adequate warning signs used prior to any construction, maintenance or demolition commencing.

Overhead power lines are near or on this site. These pose a risk of electrocution if struck or approached by lifting devices or other plant and persons working above ground level. Where there is a danger of this occurring, power lines should be, where practical, disconnected or relocated. Where this is not practical adequate warning in the form of bright coloured tape or signage should be used or a protective barrier provided.

5. MANUAL TASKS

Components within this design with a mass in excess of 25kg should be lifted by two or more workers or by mechanical lifting device. Where this is not practical, suppliers or fabricators should be required to limit the component mass.

All material packaging, building and maintenance components should clearly show the total mass of packages and where practical all items should be stored on site in a way which minimises bending before lifting. Advice should be provided on safe lifting methods in all areas where lifting may occur. Construction, maintenance and demolition of this building will require the use of portable tools and equipment. These should be fully maintained in accordance with manufacturer's specifications and not used where faulty or (in the case of electrical equipment) not carrying a current electrical safety tag. All safety guards or devices should be regularly checked and Personal Protective Equipment should be used in accordance with manufacturer's specification.

6. HAZARDOUS SUBSTANCES

POWDERED MATERIALS

Many materials used in the construction of this building can cause harm if inhaled in powdered form. Persons working on or in the building during construction, operational maintenance or demolition should ensure good ventilation and wear Personal Protective Equipment including protection against inhalation while using powdered material or when sanding, drilling, cutting or otherwise disturbing or creating powdered material.

TREATED TIMBER

The design of this building may include provision for the inclusion of treated timber within the structure. Dust or fumes from this material can be harmful. Persons working on or in the building during construction, operational maintenance or demolition should ensure good ventilation and wear Personal Protective Equipment including protection against inhalation of harmful material when sanding, drilling, cutting or using treated timber in any way that may cause harmful material to be released. Do not burn treated timber.

VOLATILE ORGANIC COMPOUNDS

Many types of glue, solvents, spray packs, paints, varnishes and some cleaning materials and disinfectants have dangerous emissions. Areas where these are used should be kept well ventilated while the material is being used and for a period after installation. Personal Protective Equipment may also be required. The manufacturer's recommendations for use must be carefully considered at all times.

SYNTHETIC MINERAL FIBRE

Fibreglass, rockwool, ceramic and other material used for thermal or sound insulation may contain synthetic mineral fibre which may be harmful if inhaled or if it comes in contact with the skin, eyes or other sensitive parts or the body. Personal Protective Equipment including protection against inhalation of harmful material should be used when installing, removing or working near bulk insulation material.

TIMBER FLOORS

This building may contain timber floors which have an applied finish. Areas where finishes are applied should be kept well ventilated during sanding and application and for a period after installation. Personal Protective Equipment may also be required. The manufacturer's recommendations for use must be carefully considered at all times.

7. CONFINED SPACES

EXCAVATION

Construction of this building and some maintenance on the building will require excavation and installation of items within excavations. Where practical, installation should be carried out using methods which do not require workers to enter the excavation. Where this is not practical, adequate support for the excavated area should be provided to prevent collapse. Warning signs and barriers to prevent accidental or unauthorised access to all excavations should be provided.

ENCLOSED SPACES

Enclosed spaces within this building may present a risk to persons entering for construction, maintenance or any other purpose. The design documentation calls for warning signs and barriers to unauthorised access. These should be maintained throughout the life of the building. Where workers are required to enter enclosed spaces, air testing equipment and Personal Protective Equipment should be provided.

SMALL SPACES

Some small spaces within this building will require access by construction or maintenance workers. The design documentation calls for warning signs and barriers to unauthorised access. These should be maintained throughout the life of the building. Where workers are required to enter small spaces they should be scheduled so that access is for short periods. Manual lifting and other manual activity should be restricted in small spaces.

8. PUBLIC ACCESS

Public access to construction and demolition sites and to areas under maintenance causes risk to workers and public. Warning signs and secure barriers to unauthorised access should be provided. Where electrical installations, excavations, plant or loose materials are present they should be secured when not fully supervised.

9. OPERATIONAL USE OF BUILDING

This building has been designed to requirements of the classification identified on the drawings. The specific use of the building is not known at the time of the design and a further assessment of the workplace health and safety issues should be undertaken at the time of fit-out for the end-user.

Where a change of use occurs at a later date a further assessment of the workplace health and safety issues should be undertaken.

10. OTHER HIGH RISK ACTIVITY

All electrical work should be carried out in accordance with *Code of Practice: Managing Electrical Risks at the Workplace, AS/NZ 3012* and all licensing requirements.

All work using Plant should be carried out in accordance with *Code of Practice: Managing Risks of Plant at the Workplace.*

All work should be carried out in accordance with *Code of Practice: Managing Noise and Preventing Hearing Loss at Work.*

Due to the history of serious incidents it is recommended that particular care be exercised when undertaking work involving steel construction and concrete placement. All the above applies.

The builder shall check and verify all all dimensions on site

Not to be used for construction, until issued as such.

IF IN DOUBT CHECK

A 21/08/2024 TENDER

REV ID Transmittal Set DESCRIPTION

Mailing Address 262 Grubb St Koongal OLD 4701 e: andrew@amfbuildingdesign.com.au m 0423 375 400

OBCC No 1068756
ABN 22143 527 198
all projects
residential,commercial,industrial



Client
Banana Shire Council
Project Name
PROPOSED REFURBISHMENTS SPORTS CLUB
RAINBOW
BILOLEA QLD 4715

Drawing Title:

Building Plans

WHS

Scale: As shown

Status: CD

Checked By:

Project No: Drawing No.:

AMF 24584

BA/02

SITE NOTE

- 1. BUILDER TO CONFIRM ALL DIMENSIONS, BUILDING SETBACKS AND PROPOSED BUILDING LEVELS ON SITE PRIOR TO THE COMMENCEMENT OF CONSTRUCTION.
- 2. BUILDER TO LOCATE AND CONFIRM THE POSITION OF ALL SERVICES ON SITE PRIOR TO COMMENCEMENT OF CONSTRUCTION. SHOULD SITE CONDITIONS DIFFER FROM THOSE INDICATED SEEK INSTRUCTIONS FROM THE DESIGNER.
- 3. SEWER LOCATION & CONNECTION POINT ARE APPROXIMATE ONLY TO BE CONFIRMED PRIOR TO CONSTRUCTION.
- 4. SITE SETBACKS ARE APPROXIMATE LOCATION SURVEY REQUIRED BY LICENCED SURVEYOR PRIOR TO CONSTRUCTION.
- 5. AMF Building Design WAIVES ANY RESPONSIBILITY FOR ANY EVENTS ARISING FROM NOT ENGAGING AND USING INDUSTRY REGISTERED BUILDING CERTIFIERS, STRUCTURAL, HYDRAULIC, MECHANICAL AND CIVIL ENGINEERS, SURVEYORS, TOWN PLANNERS AND BUILDERS.
- 6. THE BUILDER IS RESPONSIBLE FOR ENGAGING A REGISTERED CADASTRAL SURVEYOR PRIOR TO AND DURING CONSTRUCTION.
- 7. WHILST AMF Building Design TAKES CARE TO ENSURE MEASUREMENTS ARE ACCURATE WITHIN REASON, THE NATURE OF DESIGNING WITHIN EXISTING STRUCTURES WHICH MAY BE OUT OF SQUARE, NOT LEVEL OR HAVE FEATURES NOT READILY VISIBLE LIMITS DESIGNER TO BEST EFFORT. IT IS THE RESPONSIBILITY OF THE BUILDER TO REVIEW ALL MEASUREMENTS AND SPECIFICATIONS PRIOR TO COMMENCING THE BUILD AND CONTACT DESIGNER FOR ANY CLARIFICATION.

EXTENT OF CONTRACTOR'S AREA - SITE BOUNDARY OR AS AGREED WITH OWNER.





R.P.D LOT 1 SP252847 RAINBOW BILOLEA QLD 4715 Banana Shire Council

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Mailing Address 262 Grubb St Koongal QLD 4701 e: andrew@amfbuildingdesign.com.au m 0423 375 400

QBCC No 1068756 ABN 22143 527 198 all projects residential,commercial,industrial



Client
Banana Shire Council
Project Name
PROPOSED REFURBISHMENTS SPORTS CLUB
RAINBOW
BILOLEA QLD 4715

Building Plans
Location Plan

Scale: As shown

Date: JULY 24

Status: CD

Checked By:

Drawing No.:

AMF 24584

BA/03

LEGEND

AC AIR CONDITIONE CPD CUPBOARD C.TILES CERAMIC TILES DOUBLE HUNG WINDOW DH DDRWBBY MRDFRADWSSWARRL WMOBUL DOWNPIPE CLOTHES DRYER DISHWASHER HAND BASIN MAIN SWITCH BOARD SLIDE OUT PANTRY MECHANICAL VENT GARAGE DOOR REFRIDGERATOR RANGE HOOD SMOKE ALARM SLIDING GLASS DOOR SHOWER STAINLESS STEEL SINK SLIDING WINDOW SPLIT AIR CONDITIONER TOWEL RAIL
TOILER ROLL HOLDER
TOILET SUITE WASHING MACHINE WALL OVEN VANITY BASIN VINYL FLOOR FINISH DOOR NUMBER 1

WINDOW NUMBER

GENERAL NOTES

CONTRACTOR AND ALL SUBCONTRACTORS SHALL CHECK ALL DIMENSIONS AND EXISTING CONDITIONS BEFORE COMMENCING CONSTRUCTION.

CONTRACTORS SHALL REPORT ANY DISCREPENCIES (ON THE DRAWINGS OR ON SITE) TO SUPERINTENDANT BEFORE COMMENCING OR CONTINUING WITH CONSTRUCTION. FIGURED DIMENSIONS SHALL TAKE PRECEDENCE OVER SCALED DIMENSIONS.

ALL WORKMANSHIP IS TO COMPLY IN ALL RESPECTS WITH THE RELEVANT AUSTRALIAN STANDARDS.


THE BUILDING IS TO REMAIN USEABLE BY THE Banana Shire Council AT ALL TIMES (INCLUDING POWER/AC/ ACCESS) IN ADVANCE ADVISE Banana Shire Council OF ANY REQUIRED POWER OUTAGES. THE BUILDER IS TO PROVIDE 7 DAYS NOTICE TO THE Banana Shire Council FOR APPROVAL.

CONSTRUCTION WORK IS TO BE ADEQUATELY BARRICADED FROM THE EXISTING WORKSHOP WITH CONSTRUCTION HOARDING (PLYWOOD OR SIMILAR) AND FIXED SECURELY SO IT CAN'T BE PUSHED OR FALL OVER.


FIRE EVACUATION PATH SHALL BE MAINTAINED AT ALL TIMES, PARTICULARLY WHEN THE SITE IS CLOSED

ALL CONSTRUCTION DUST AND MESS IS TO BE REMOVED AND EXISTING TO BE CLEANED / REPLACED TO MAKE GOOD.

THE SITE IS TO BE KEPT CLEAN AND TIDY AT ALL TIMES.

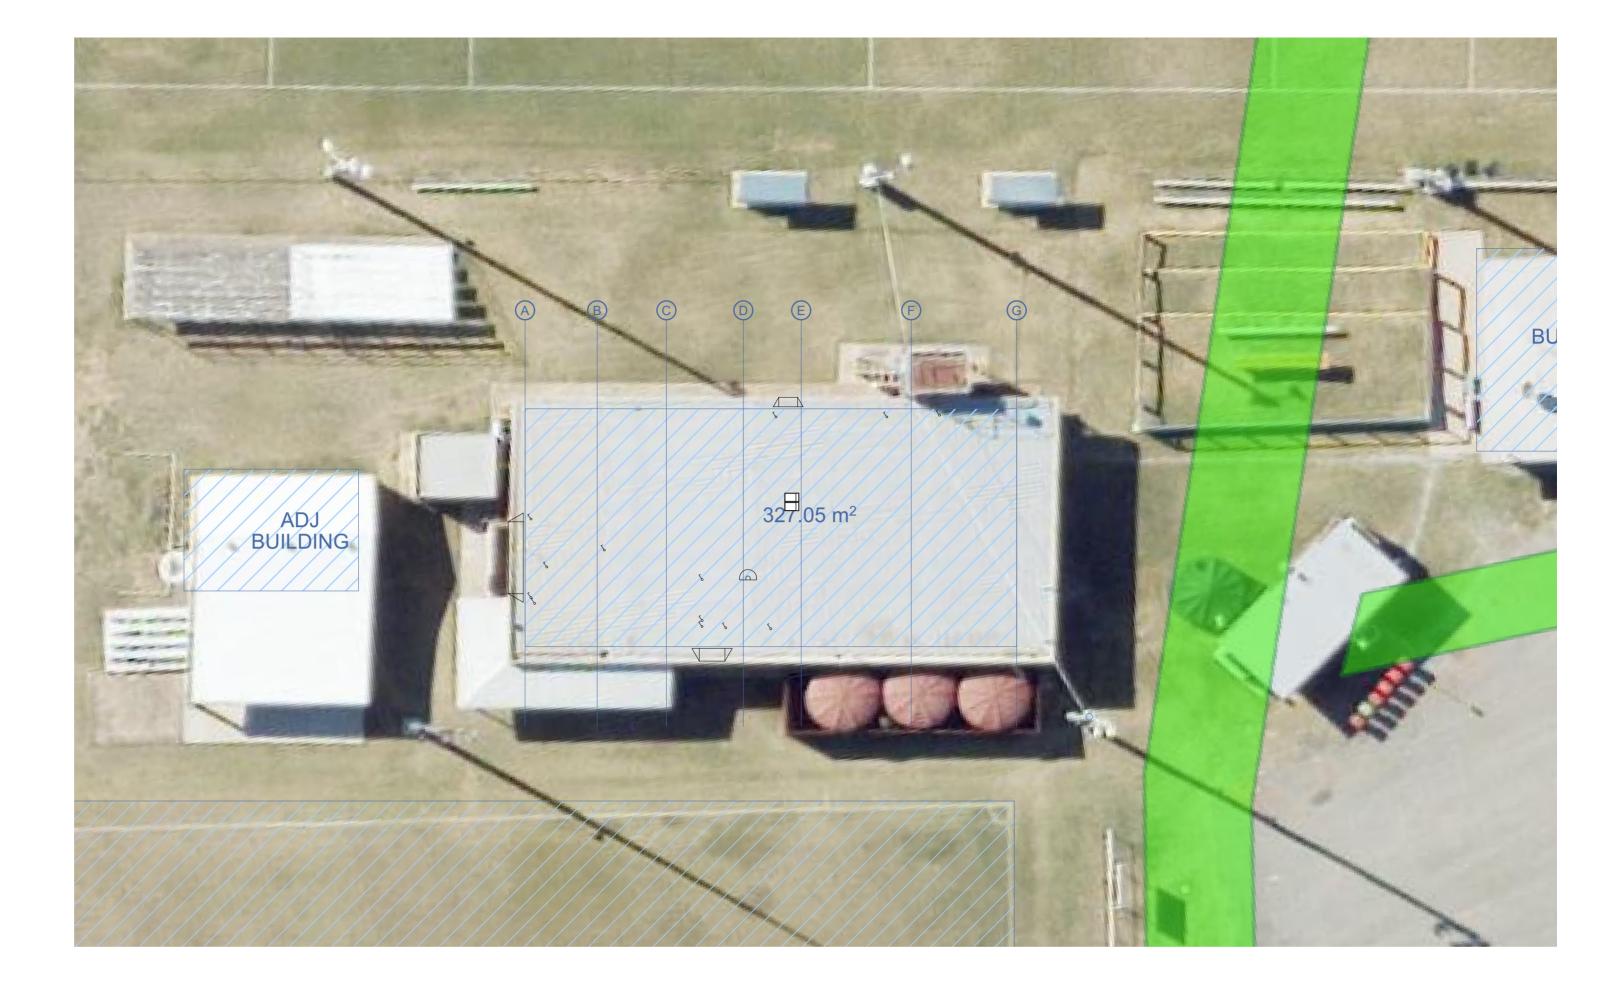

Site Plan
Scale 1:200

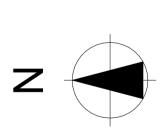

The builder shall check and verify all all dimensions on site Not to be used for construction, until issued as such.				
IF IN DOUBT CHECK	A REV ID	21/08/2024 Transmittal Set Date	TENDER DESCRIPTION	

Mailing Address 262 Grubb St Koongal QLD 4701 e: andrew@amfbuildingdesign.com.au m 0423 375 400

QBCC No 1068756 ABN 22143 527 198 all projects residential,commercial,industrial



Client
Banana Shire Council
Project Name
PROPOSED REFURBISHMENTS SPORTS CLUB
RAINBOW
BILOLEA QLD 4715

Building Plans
SITE PLAN

Scale: As shown

Date: JULY 24

Status: CD

Checked By:

Project No:

Drawing No.:

BA/04

 $BIMcloud: amfbuilding design-BIMcloud Software \ as \ a \ Service/24584\ Rainbow\ St\ Sports\ Club_BSC/24584_Rainbow\ SC_070724$

DEMOLITION NOTES

- 1. PROTECT EXISTING BUILDING, EXTERNAL WALLS, ROOF, SOFFITS, AND FLOOR SLABS, AND FOOTPATHS FROM CONSTRUCTION DAMAGE AND DUST FOR THE DURATION OF THE DEMOLITION AND CONSTRUCTION PERIOD. USE A COMBINATION OF SAFETY BARRICADES, HESSIAN AND DROP SHEETS TO PROTECT THE EXISTING SCHOOL BUILDINGS FROM MOVEMENT OF CONSTRUCTION EQUIPMENT, DUST AND DAMAGE
- 2. CAP, ISOLATE AND SAFELY TERMINATE ALL REDUNDANT SERVICES PRIOR TO THE COMMENCEMENT OF DEMOLITION.
- 3. MAKE GOOD ALL EXISTING SURFACES WHERE DISTURBED BY THE DEMOLITION / NEW WORKS. MAKE GOOD (INCL. TOUCH UP & PAINT) ALL CEILINGS, WALLS, CORNICES & SKIRTINGS WHERE DISTURBED TO MATCH EXISTING BY DEMOLITION WORK AND NEW
- 4. MAINTAIN EXISTING SERVICES (POWER, LIGHTING, DATA, A/C, WATER, DRAINAGE, FIRE DETECTION, ELECTRONIC SECURITY) TO NON-RENOVATED PARTS OF EXISTING BUILDING. I.E EXIT LIGHTING FOR THE DURATION OF THE CONSTRUCTION PERIOD. ADVISE THE Banana Shire Council IN ADVANCE OF ANY PLANNED DISRUPTION TO EXISTING SERVICES.

NOTES.

REMOVE PART WALL TO PROVIDE 1400 WIDE OPENING EACH SIDE ENSURE 400MM BLOCK SUPPORT EACH SIDE FOR E.150 | BEAM. ENSURE BLOCK CORE FILLED

EXISTING CRACK ADJCAENT TO COLUMN RECTIFICATION

REMOVE PART WALL ENSURE 500MM NIB EACH SIDE

ENLARGE OPENINGS SUITABLE FOR 920 DOOR LEAF OPENING.


CUT IN 1800MM WIDE OPENING ENSURE NON LOAD BEARING LOAD BEARING - PROVIDE GALV STEEL LINTEL









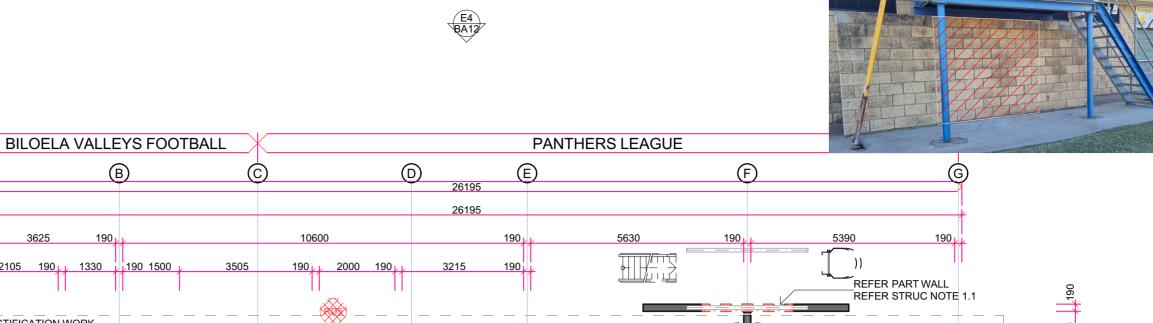

2105 190 1330 GAS BOTTLE ENCLOSURE WITH HOT RECTIFICATION WORK WATER UNIT MOUNTED REFER STRUC NOTE 1.2 920 NEW.M.SEAT NEW.M.SEAT REFER PART WALL REFER STRUC NOTE 1.3 4 STORE URINAL ISLAND BENCH REFER PART WALL REFER STRUC NOTE 1.4 HOT WATER UNIT MOUNTED ON WALLS WT WT WALLS **OPENINGS OVERALL** 190 1228 70 1014 190 2903 190 RELOCATE GAS BOTTLE PROVIDE NEW ENCLOSURE 2312 190 1004 190 1709






DESIGN & CONSTRUCTION DOCUMENTATION COMPILED TO ACQUIRE TENDER PRICE. FURTHER MORE DESIGN AND DOCUMENTATION MAY BE REQUIRED PRIOR TO CONSTRUCTION AND TO OBTAIN APPROVAL.



DOOR NUMBER 1 WINDOW NUMBER 8



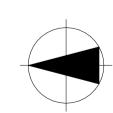

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IF IN DOUBT CHECK

Mailing Address 262 Grubb St 21/08/2024 **TENDER** Fransmittal Set DESCRIPTION **REV ID**

Koongal QLD 4701

m 0423 375 400

QBCC No 1068756 ABN 22143 527 198

residential, commercial, industrial


all projects


e: andrew@amfbuild

Banana Shire Council Project Name PROPOSED REFURBISHMENTS SPORTS CLUB **RAINBOW BILOLEA QLD 4715**

Building Plans EXISTING & DEMOLITION

Scale: As shown	Date: JULY 24
Status: CD	Checked By:
Project No:	Drawing No.:
AMF 24584	BA/05

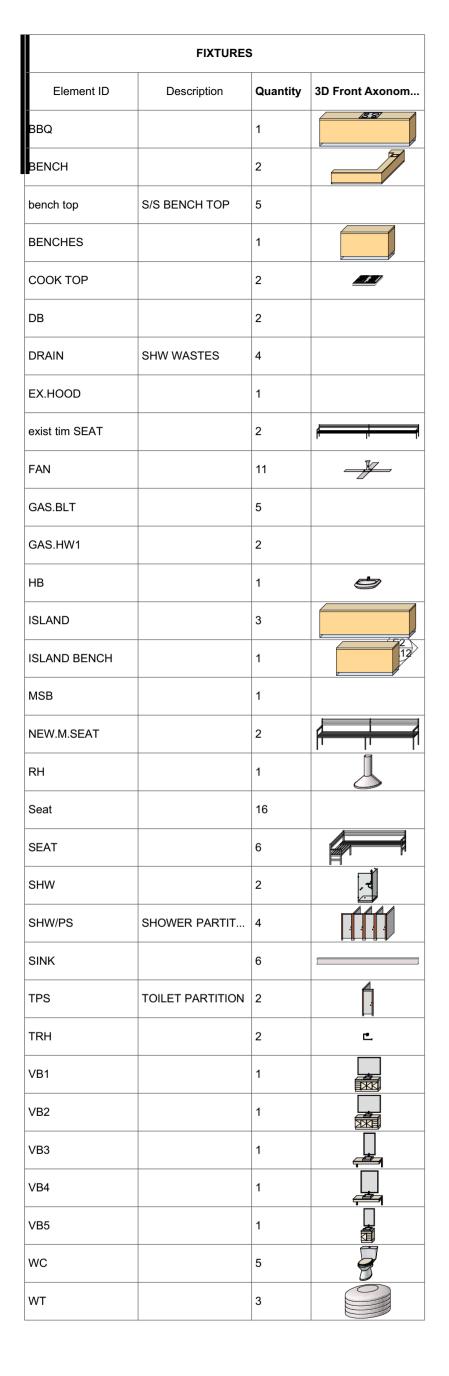

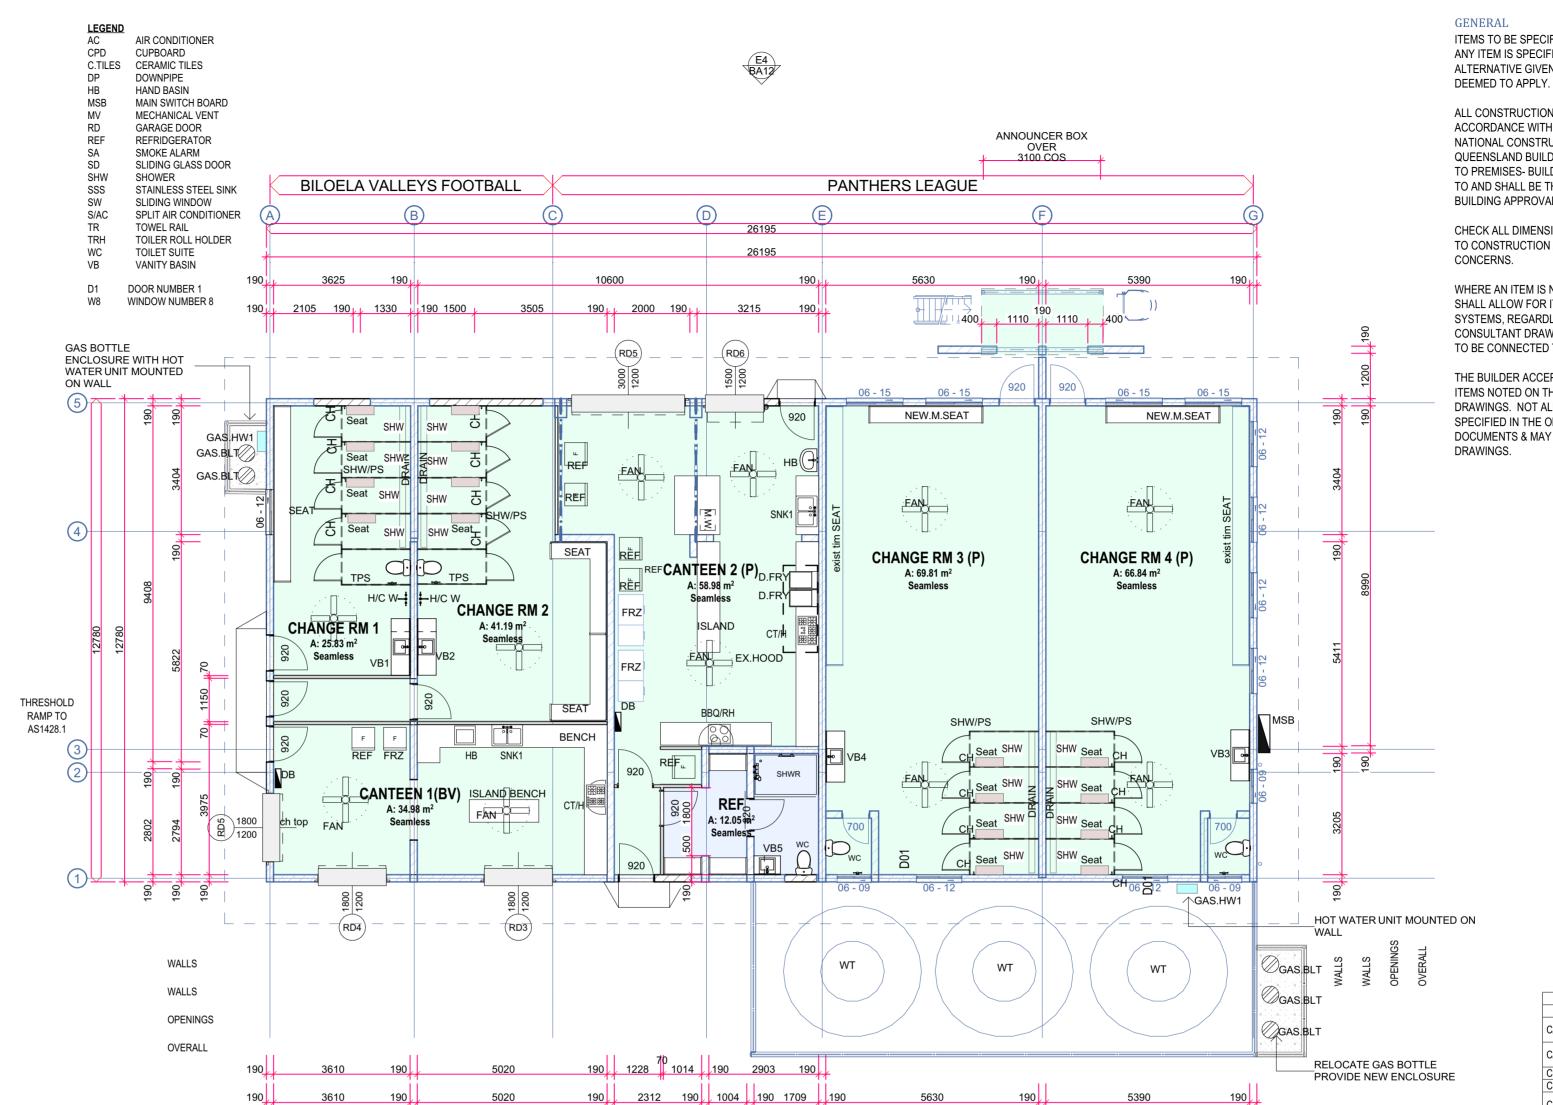

ITEMS TO BE SPECIFIED OR EQUAL APPROVED. WHERE ANY ITEM IS SPECIFIED DIFFERENTLY, OR AN ALTERNATIVE GIVEN, THE HIGHER QUALITY PRODUCT IS

ALL CONSTRUCTION SHALL BE GENERALLY IN ACCORDANCE WITH THE REQUIREMENTS OF THE NATIONAL CONSTRUCTION CODE OF AUSTRALIA, QUEENSLAND BUILDING ACT AND DISABILITY (ACCESS TO PREMISES- BUILDINGS) STANDARD 2010 REFERRED TO AND SHALL BE THE CURRENT EDITION AT TIME OF BUILDING APPROVAL CERTIFICATION.


CHECK ALL DIMENSIONS AND SETOUTS ON-SITE PRIOR TO CONSTRUCTION AND NOTIFY PROPRIETOR OF ANY CONCERNS

WHERE AN ITEM IS NOTED, IT IS ASSUMED THE BUILDER SHALL ALLOW FOR ITS CONNECTION TO THE BUILDING SYSTEMS, REGARDLESS IF SHOWN OTHERWISE ON CONSULTANT DRAWINGS (I.E. A FIELD INLET SHOWN IS TO BE CONNECTED TO THE SW SYSTEM).

THE BUILDER ACCEPTS TO SUPPLY AND INSTALL ALL ITEMS NOTED ON THE ARCHITECTURAL & CONSULTANT DRAWINGS. NOT ALL TRADE SPECIFIC DETAIL MAY BE SPECIFIED IN THE ONE PARTICULAR CONSULTANT DOCUMENTS & MAY BE SPREAD OVER SEVERAL DRAWINGS.



FLOOR AREA					
NAME	Measured Area				
ANTEEN 1(BV)	34.98				
ANTEEN 2 (P)	58.98				
HANGE RM 1	25.83				
HANGE RM 2	41.19				
HANGE RM 3 (P)	69.81				
HANGE RM 4 (P)	66.84				
EF	12.05				
	309.68 m ²				

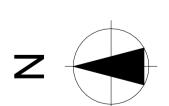



The builder shall check and verify all all dimensions on site

Not to be used for construction, until issued as such.

IF IN DOUBT CHECK

A 21/08/2024

TENDER

Mailing Address 262 Grubb St Koongal QLD 4701 e: andrew@amfbuildingdesign.com.au m 0423 375 400

OBCC No 1068756 ABN 22143 527 198

BUILDING D

DESCRIPTION

all projects

residential, commercial, industrial



Client
Banana Shire Council
Project Name
PROPOSED REFURBISHMENTS SPORTS CLUB
RAINBOW
BILOLEA QLD 4715

Building Plans
Proposed Ground Floor Plan

AMF 24584	BA/06
Project No:	Drawing No.:
Status: CD	Checked By:
Scale: As shown	Date: JULY 24


REV ID

Transmittal Set

<u>LEGEND</u>

AC AIR CONDITIONER
CPD CUPBOARD
C.TILES CERAMIC TILES
DH DOUBLE HUNG WINDOW CLOTHES DRYER DISHWASHER HAND BASIN MAIN SWITCH BOARD SLIDE OUT PANTRY MECHANICAL VENT GARAGE DOOR REFRIDGERATOR RANGE HOOD SMOKE ALARM SLIDING GLASS DOOR SHOWER STAINLESS STEEL SINK SLIDING WINDOW SPLIT AIR CONDITIONER TOWEL RAIL
TOILER ROLL HOLDER TOILET SUITE WASHING MACHINE
WALL OVEN
VANITY BASIN
VINYL FLOOR FINISH

> DOOR NUMBER 1 WINDOW NUMBER 8

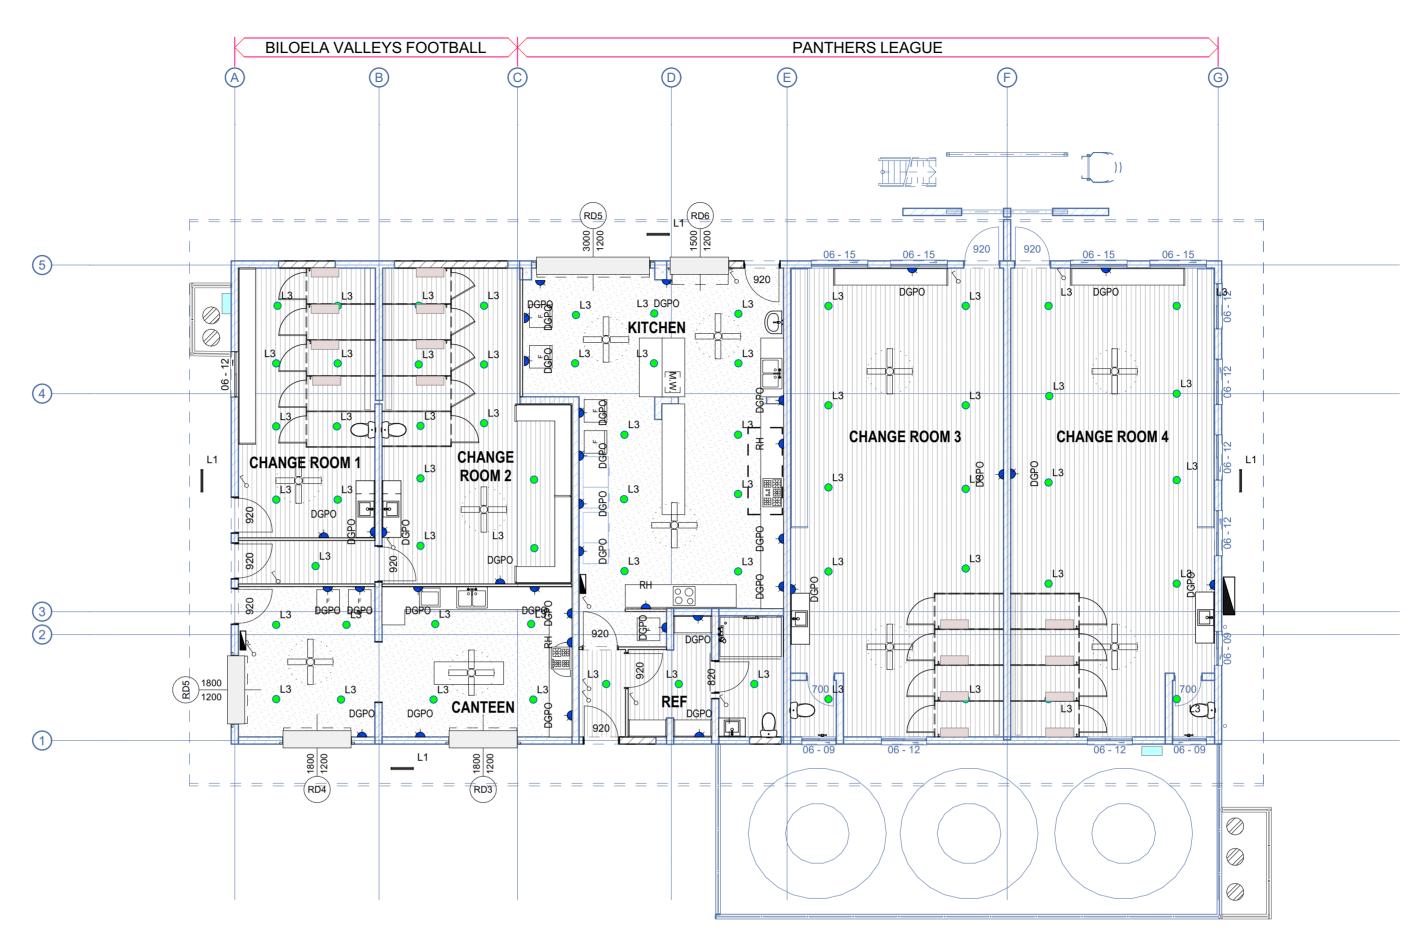

	ELECTRICAL						
Element ID	Quantity	3D Axonometry					
FREEZER			1				
GPO	DGPO		38	0			
L1	_		4				
L3			68				
RH	RH		1				
SINK	8		13				

ELECTRICAL LAYOUT Scale 1:100

The builder shall check and verify all all
dimensions on site
Not to be used for construction, until issued
as such.
IF IN DOUBT CHECK

Transmittal Set	DESCRIPTION	residential,commercial,industrial
21/08/2024	TENDER	ABN 22143 527 198 all projects
		QBCC No 1068756
		e: andrew@amfbuildingdesign.c m 0423 375 400
		262 Grubb St Koongal QLD 4701
		Mailing Address

Banana Shire Council Project Name PROPOSED REFURBISHMENTS SPORTS CLUB **RAINBOW** BILOLEA QLD 4715

Building Plans Electrical Layouts

Scale: **As shown** Date: JULY 24 Status: **CD** Checked By: Project No: Drawing No.: **AMF 24584 BA/14**

DEMOLITION NOTES

- 1. PROTECT EXISTING BUILDING, EXTERNAL WALLS, ROOF, SOFFITS, AND FLOOR SLABS, AND FOOTPATHS FROM CONSTRUCTION DAMAGE AND DUST FOR THE DURATION OF THE DEMOLITION AND CONSTRUCTION PERIOD. USE A COMBINATION OF SAFETY BARRICADES, HESSIAN AND DROP SHEETS TO PROTECT THE EXISTING SCHOOL BUILDINGS FROM MOVEMENT OF CONSTRUCTION EQUIPMENT, DUST AND DAMAGE
- 2. CAP, ISOLATE AND SAFELY TERMINATE ALL REDUNDANT SERVICES PRIOR TO THE COMMENCEMENT OF DEMOLITION.
- 3. MAKE GOOD ALL EXISTING SURFACES WHERE DISTURBED BY THE DEMOLITION / NEW WORKS. MAKE GOOD (INCL. TOUCH UP & PAINT) ALL CEILINGS, WALLS, CORNICES & SKIRTINGS WHERE DISTURBED TO MATCH EXISTING BY DEMOLITION WORK AND NEW WORKS.
- 4. MAINTAIN EXISTING SERVICES (POWER, LIGHTING, DATA, A/C, WATER, DRAINAGE, FIRE DETECTION, ELECTRONIC SECURITY) TO NON-RENOVATED PARTS OF EXISTING BUILDING. I.E EXIT LIGHTING FOR THE DURATION OF THE CONSTRUCTION PERIOD. ADVISE THE Banana Shire Council IN ADVANCE OF ANY PLANNED DISRUPTION TO EXISTING SERVICES.


EXTINGUISHERS

PROVIDE FIRE EXTINGUISHERS APPROPRIATE TO THE LOCATION IN ACCORDANCE WITH THE NATIONAL CONSTRUCTION CODE SECT. E1.6 AND AS 2444.

MECHANICAL VENTILATION

PROVIDE A MECHANICAL VENTILATION SYSTEM TO AREAS GENERALLY AND A SEPARATE SYSTEM TO ALL AMENITIES, SECTION F4.5 OF THE NATIONAL CONSTRUCTION CODE AND AS 1668.2 & AS/NZ 3666.1. INACCORDANCE WITH MECHANICAL ENGINEER'S DRAWINGS. PROVIDE SOUND AND FIRE RATED ACCESS PANELS IN ACCORDANCE WITH NATIONAL CONSTRUCTION CODE REQUIREMENTS. DUCTS/RISERS SHALL BE IN ACCORDANCE WITH BCA SECT. C3.12, C3.13, C3.15.

PLASTERBOARD CEILINGS AND WALL LININGS SHALL BE INSTALLED IN ACCORDANCE WITH AS 2785 AND THE MANUFACTURER'S SPECIFICATIONS AND DETAILS. SUSPENDED CEILING SYSTEM SHALL BE A PROPRIETARY SYSTEM SUCH AS THE 'RONDO' KEY-LOCK SYSTEM AND ALL PLASTERBOARD ON EXTERNAL BLOCK WALLS SHALL BE INSTALLED ON A PROPRIETARY STEEL FURRING CHANNEL SYSTEM.

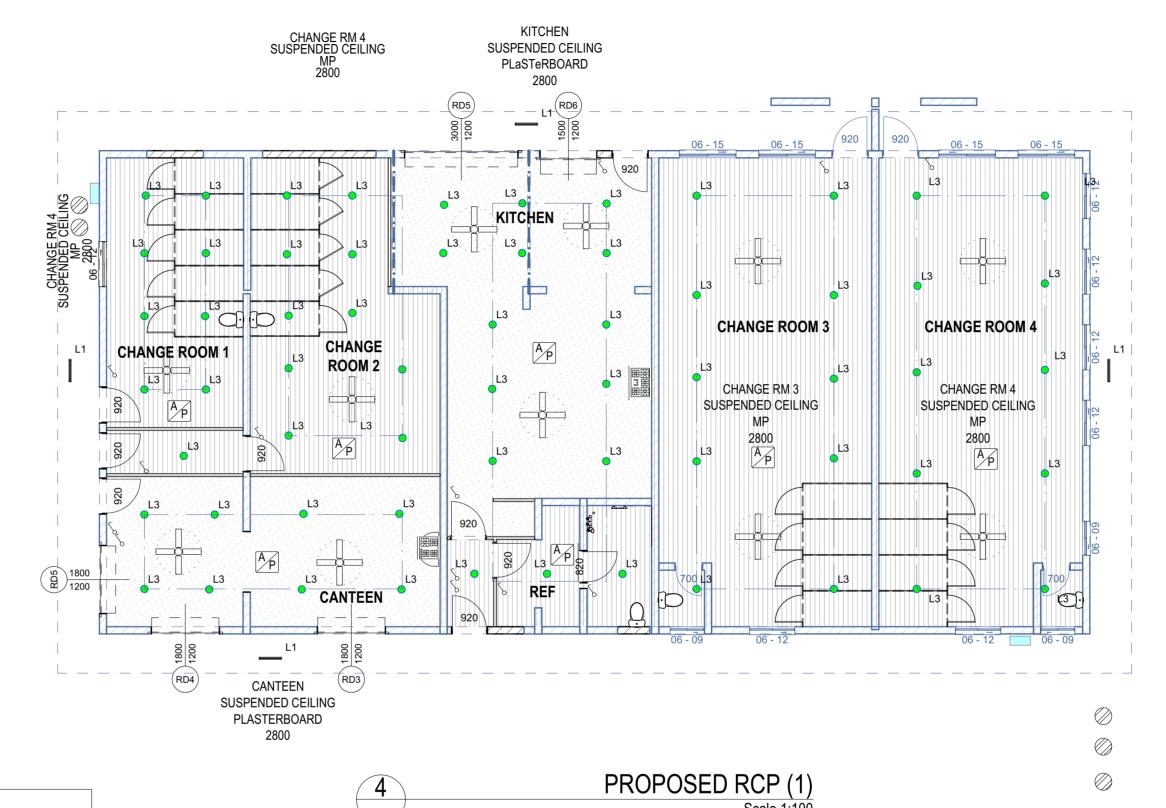


LEGEND

AIR CONDITIONER 600 X 600 ACCESS PANEL CH2700 CEILING HEIGHT 2700MM DOWNPIPE FIBRE CEMENT SHEETING

FC L1 LIGHT FIXTURE NO 1 MAIN SWITCH BOARD MECHANICAL VENT PLASTERBOARD GARAGE DOOR RANGEHOOD SMOKE ALARM SLIDING WINDOW

DOOR NUMBER 1 W8 WINDOW NUMBER 8

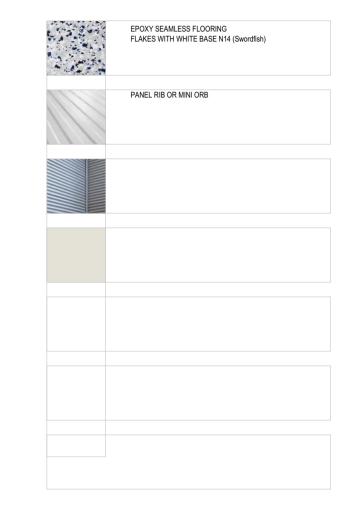

	ELECTRICAL							
Element ID	2D Plan Preview	Custom text 1	Quantity	3D Axonometry				
FREEZER			1					
GPO	DGPO		38	0				
L1	_		4					
L3			68					
RH	RH		1	0				



Client Banana Shire Council Project Name PROPOSED REFURBISHMENTS SPORTS CLUB **RAINBOW BILOLEA QLD 4715**

Drawing Title: **Building Plans Ceiling Plan**

Scale: **As shown** Date: JULY 24 CD Status: Checked By: Project No: Drawing No.: **AMF 24584 BA/08**

The builder shall check and verify all all dimensions on site Not to be used for construction, until issued

as such.

IF IN DOUBT CHECK

Mailing Address 262 Grubb St Koongal QLD 4701 e: andrew@amfbuild m 0423 375 400 QBCC No 1068756 ABN 22143 527 198 21/08/2024 **TENDER**

DESCRIPTION

all projects


residential,commercial,industrial

13


Transmittal Set

REV ID



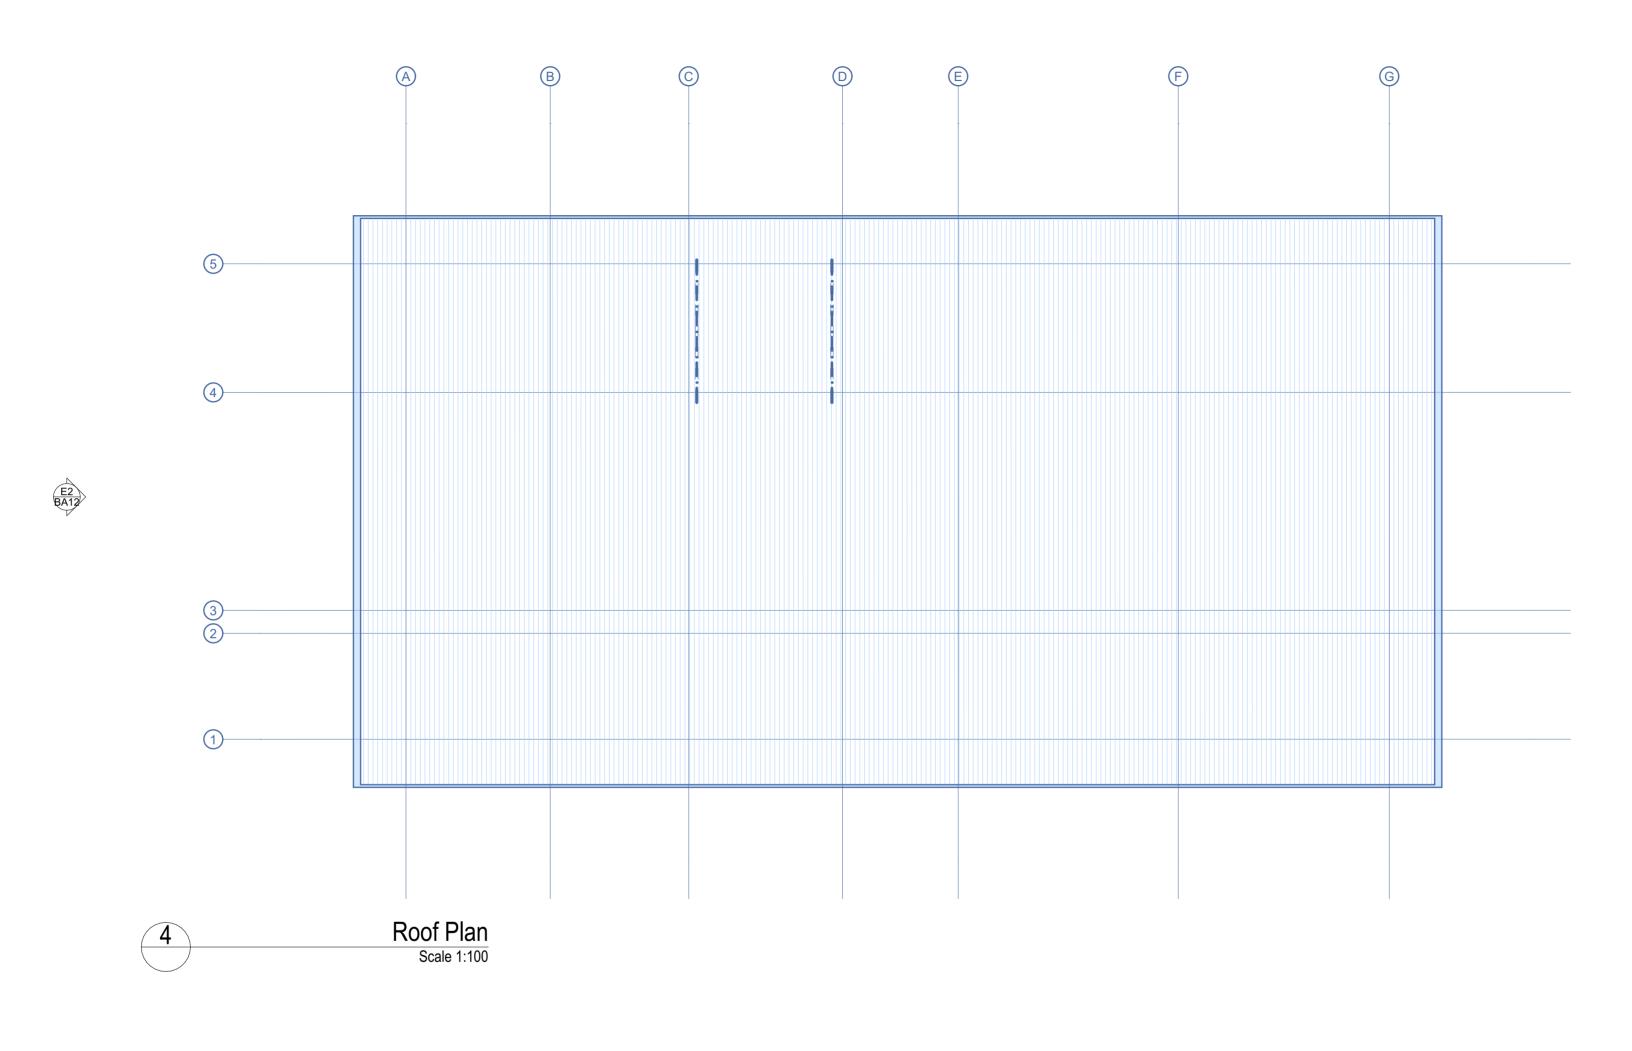



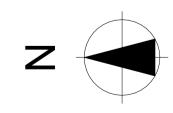

The builder shall check and verify all all				Mailing Address 262 Grubb St		Client	Drawing Title:	Scale: As shown	Date: JULY 24
dimensions on site Not to be used for construction, until issued				Koongal QLD 4701 e: andrew@amfbuildingdesign.com.au		Banana Shire Council Project Name	Building Plans	Status: CD	Checked By:
as such. IF IN DOUBT CHECK				m 0423 375 400	amif	PROPOSED REFURBISHMENTS SPORTS CLUB	Roof Plan	Project No:	Drawing No.:
	А	21/08/2024	TENDER	OBCC No 1068756 ABN 22143 527 198 all projects	BUILDING DESIGN	RAINBOW BILOLEA QLD 4715		AMF 24584	BA/09
	REV ID	Tues a sucitival Cat	DESCRIPTION	all projects residential.commercial.industrial	V	BILOLEA QLD 4715		AIVII 24304	L

WORK PLACE HEALTH AND SAFETY.

A COMPLETE SITE AND DESIGN SAFETY REVIEW AND ACTION PLAN MUST BE UNDERTAKEN AS PART OF ANY WORKS INCORPORATED IN THE BUILDING OUTCOME.

ENGINEERING

TO BE READ IN CONJUNCTION WITH ENGINEER'S DRAWINGS AND SPECIFICATIONS. REFER TO ENGINEERING DRAWINGS FOR STRUCTURAL DESIGN, WALL BRACING.

PLUMBING, DRAINAGE, WATER RETICULATION TO HYDRAULIC CONSULTANT'S DETAILS.

SEWER CONNECTION

ALL PLUMBING POINTS TO BE CONNECTED TO SEWER AS PER COUNCIL REQUIREMENTS AND IN ACCORDANCE WITH THE HYDRAULIC ENGINEER'S DRAWINGS.

STORM WATER

ALL STORM WATER SHALL DISCHARGE AS PER COUNCIL REQUIREMENTS AND IN ACCORDANCE WITH THE HYDRAULIC ENGINEER'S DRAWINGS.

CONSTRUCTION

BUILDER TO ALLOW TO CLEAR AND PREPARE CONSTRUCTION ZONE SUITABLE FOR DETAILED WORKS.

ALL INTERNAL ABUTTING FLOOR FINISHES TO FINISH FLUSH

CONCEAL ALL PLUMBING IN WALLS & VOIDS TO BE NEAT & CONSUME MINIMUM SPACE IN CUPBOARDS.

WATERPROOFING OF INTERNAL WET AREAS SHALL COMPLY WITH AS3740. PROVIDE A PROPRIETARY LIQUID OR SHEET MEMBRANE SYSTEM AND FALL TO WASTES.

STEELWORK

ALL STRUCTURAL STEEL WORK, FITTINGS & FIXTURES SHALL BE HOT DIPPED GALVANISED. ALL OTHER STEELWORK, FITTING & FIXTURES SHALL BE PASSIVE GALVANISED.


ALL TIMBER TO BE IN ACCORDANCE WITH THE NATIONAL CONSTRUCTION CODE, STANDARDS AUSTRALIA AS1684.1-1999 AND THE STRUCTURAL ENGINEER'S DRAWINGS.


AS CONSTRUCTED RECORDS


BUILDER TO PROVIDE 'AS CONSTRUCTED' DRAWINGS OF ALL SERVICES, SETOUTS & LEVELS TO COUNCIL & OWNER.

EXIT SIGNS & EMERGENCY LIGHTING

PROVIDE ILLUMINATED EXIT SIGNS & LIGHTING TO COMPLY WITH SECT. E4.2 & E4.7 OF THE BCA AND AS2293 PART 1. IN ACCORDANCE WITH THE ELECTRICAL ENGINEER'S DRAWINGS.

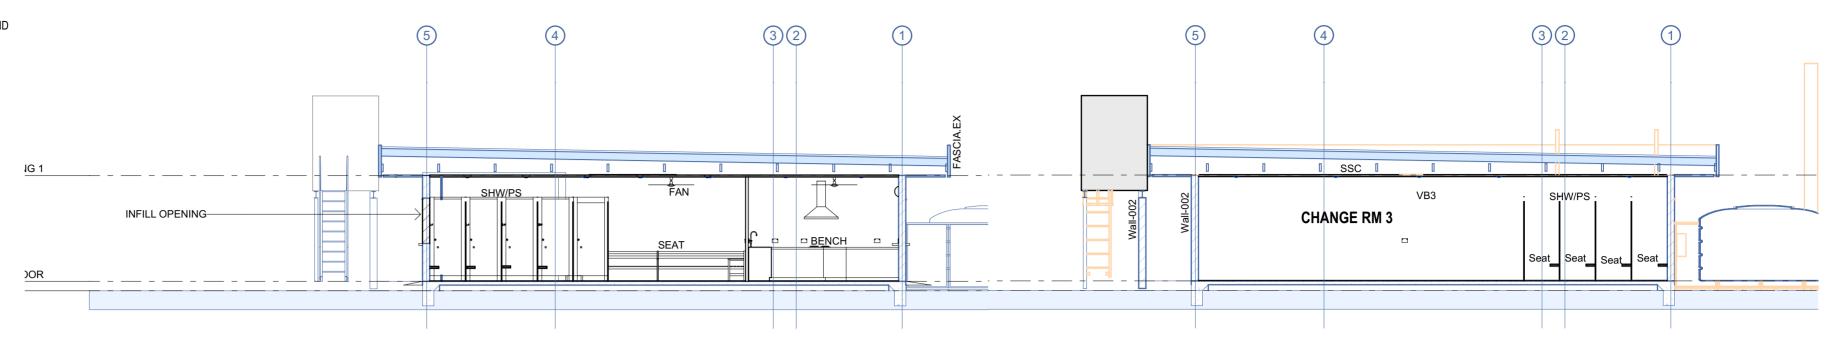


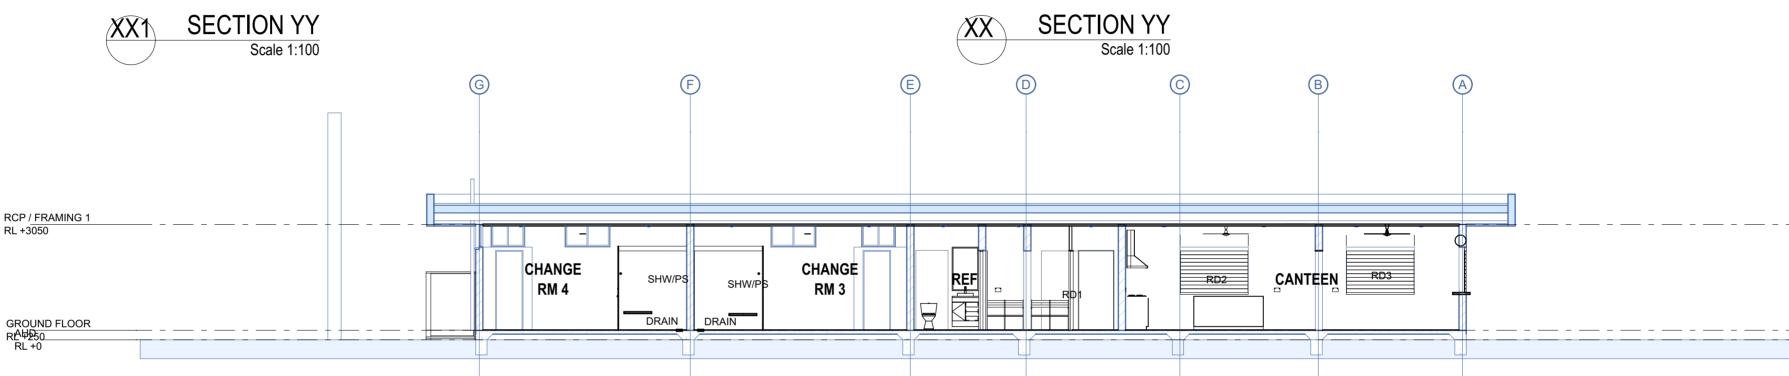


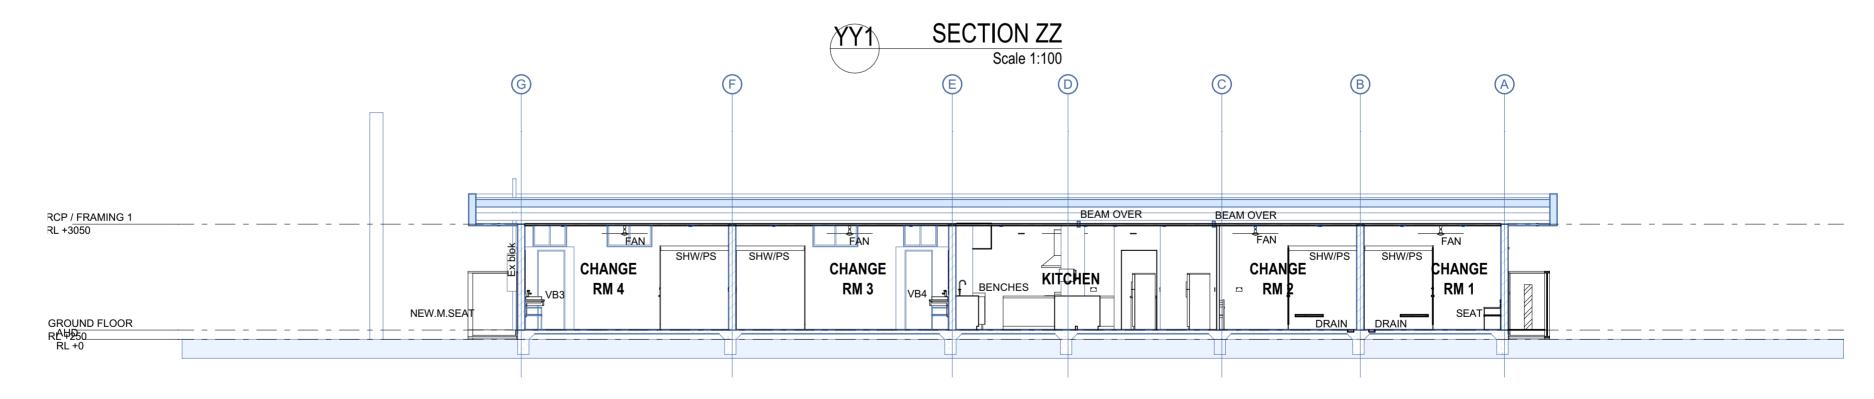




Scale: **As shown** Date: JULY 24 The builder shall check and verify all all Drawing Title: Mailing Address 262 Grubb St Client dimensions on site Banana Shire Council **Building Plans** Koongal QLD 4701 CD Status: Not to be used for construction, until issued Checked By: e: andrew@amfbuild Project Name m 0423 375 400 as such. PROPOSED REFURBISHMENTS SPORTS CLUB **Typical Section 1/2** Project No: Drawing No.: IF IN DOUBT CHECK QBCC No 1068756 **RAINBOW AMF 24584 BA/07** 21/08/2024 ABN 22143 527 198 **TENDER BILOLEA QLD 4715** all projects Transmittal Set **REV ID** DESCRIPTION residential,commercial,industrial

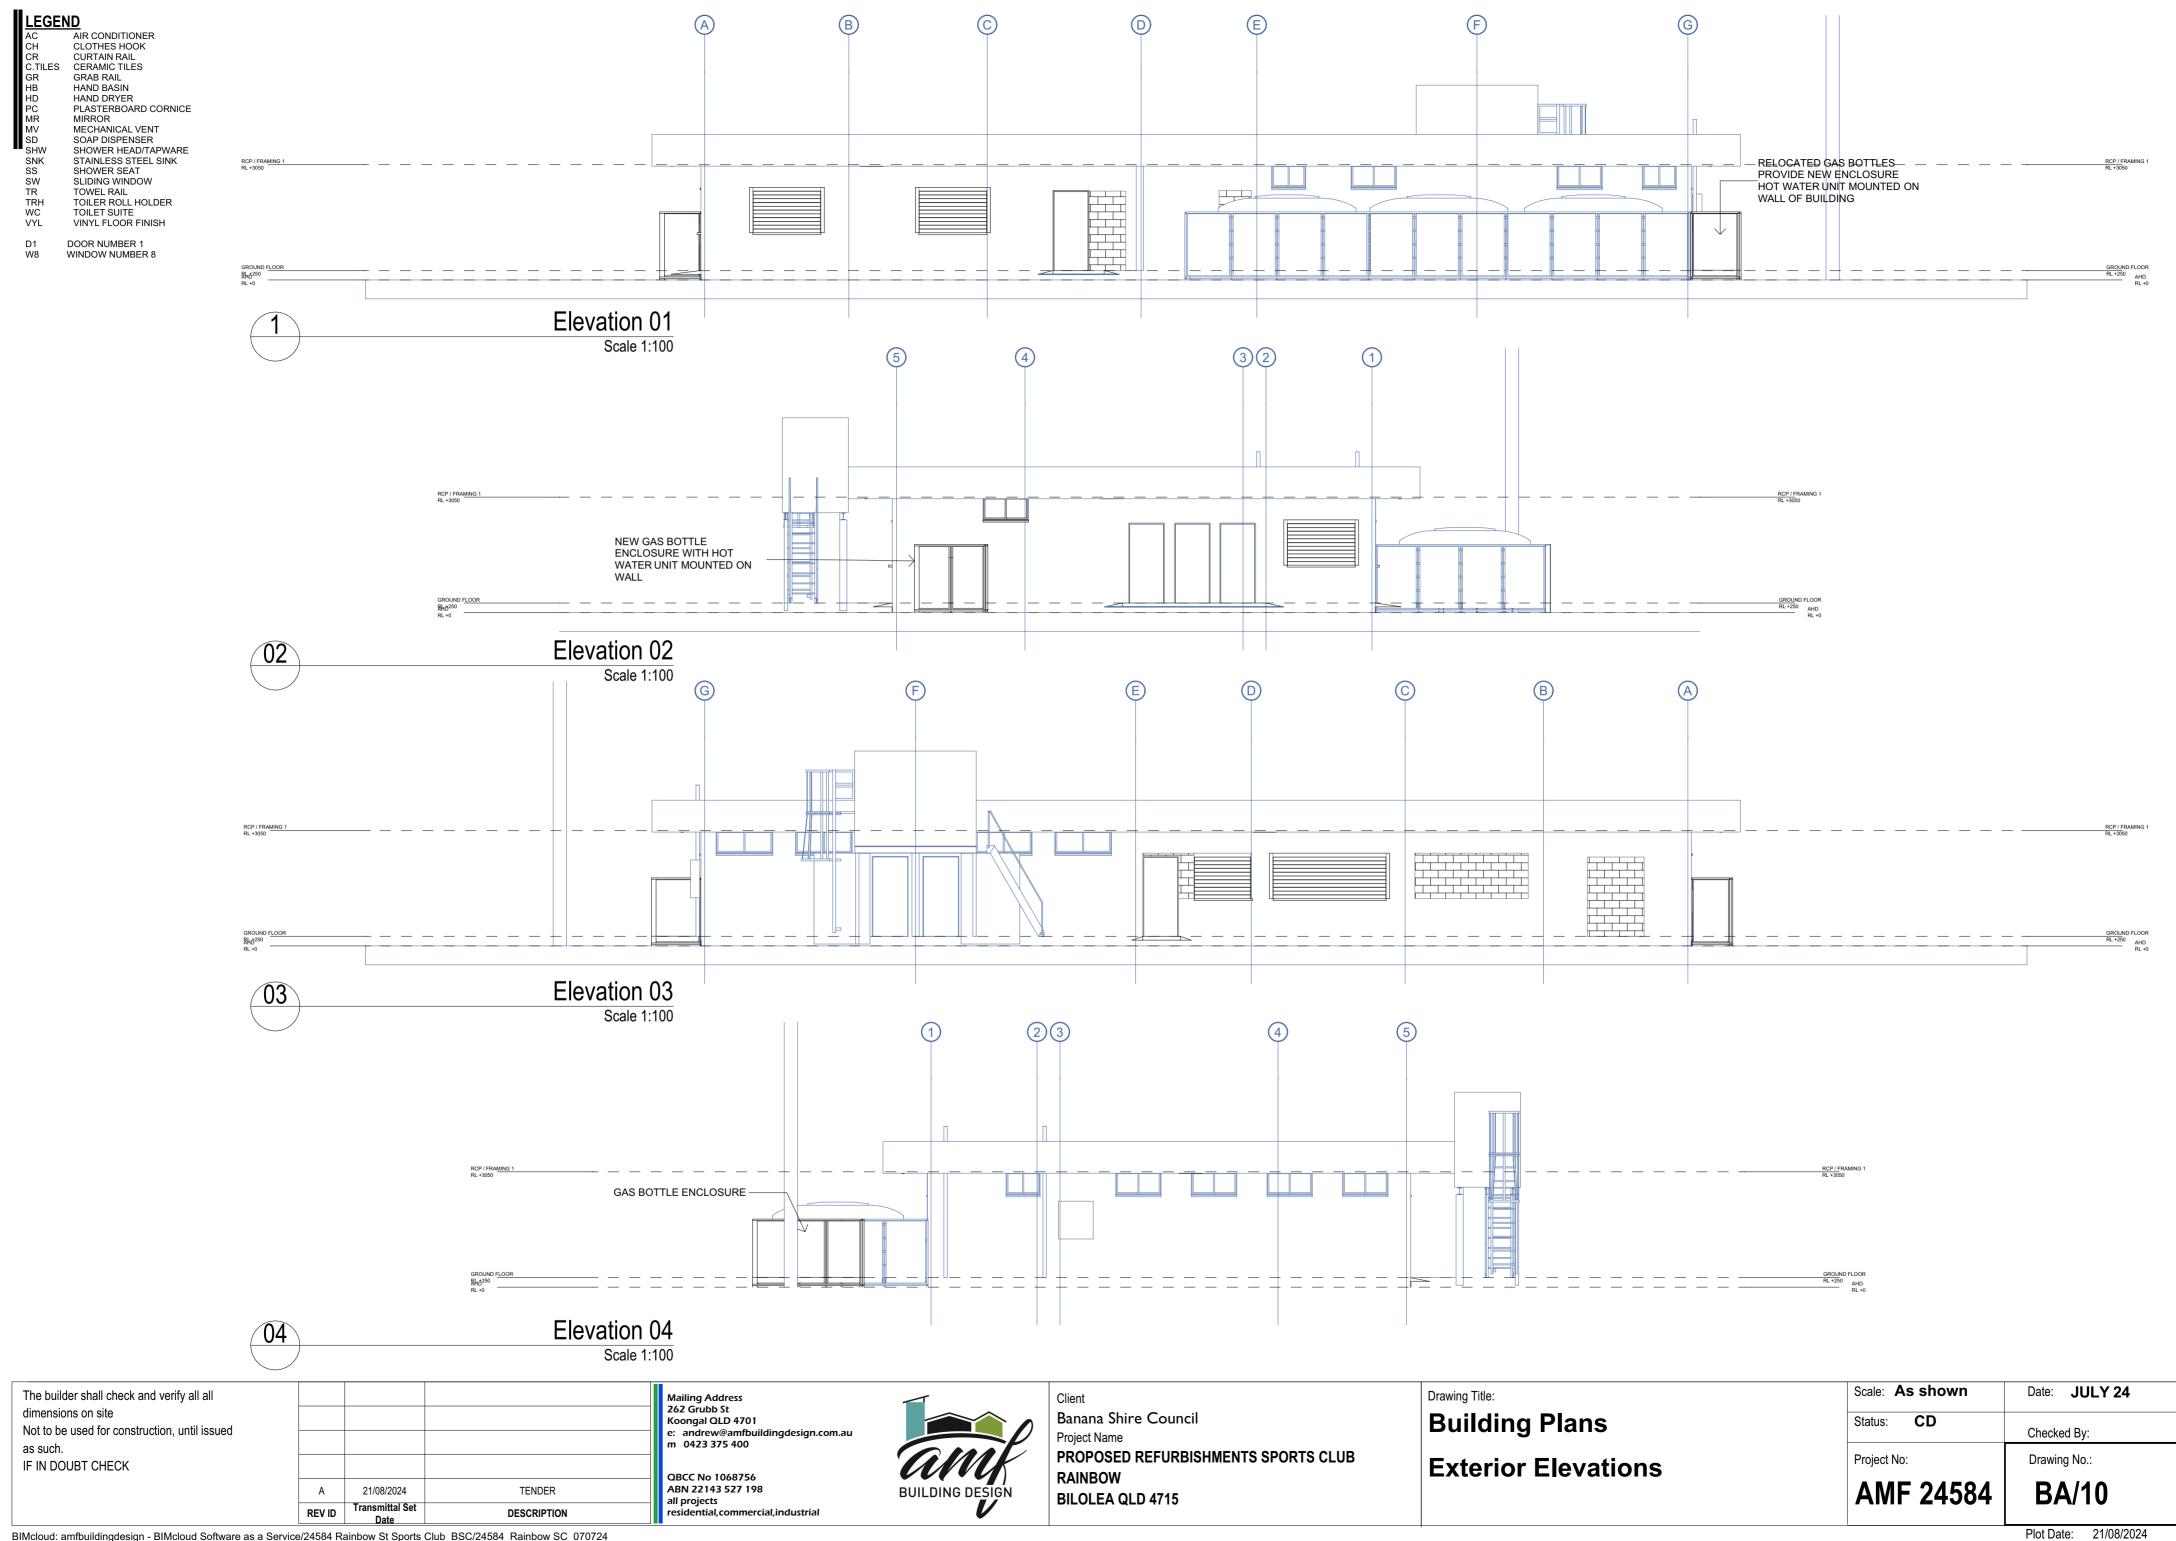

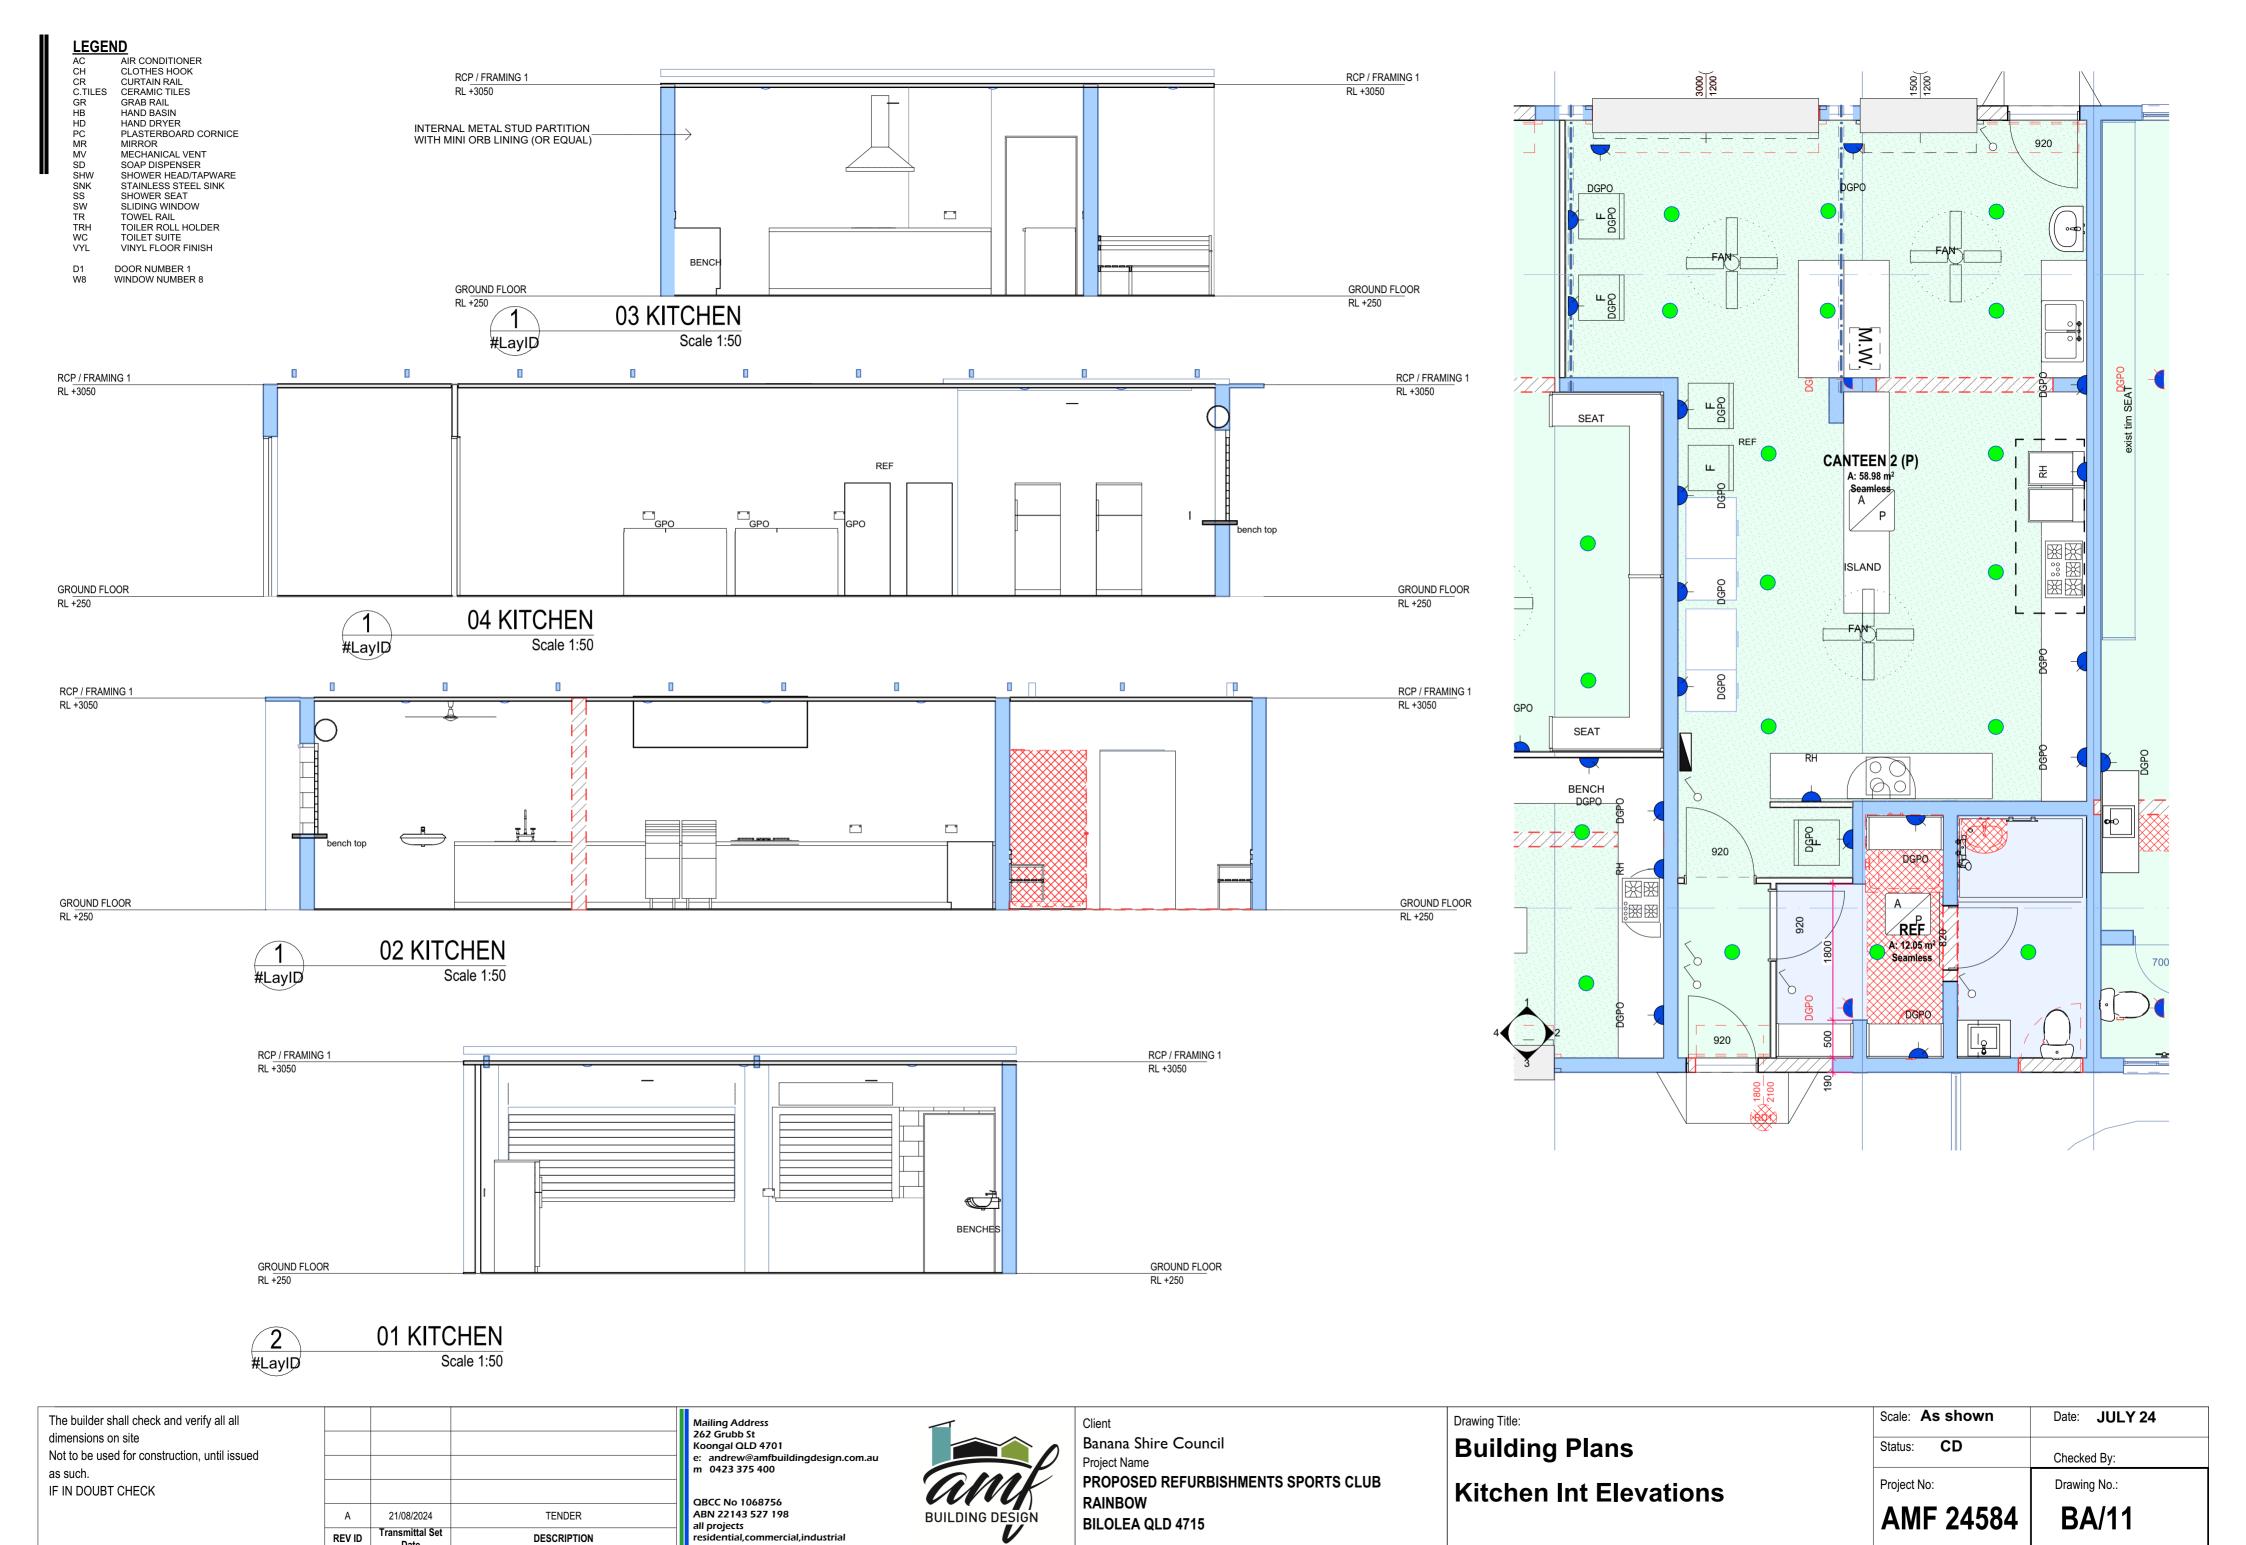

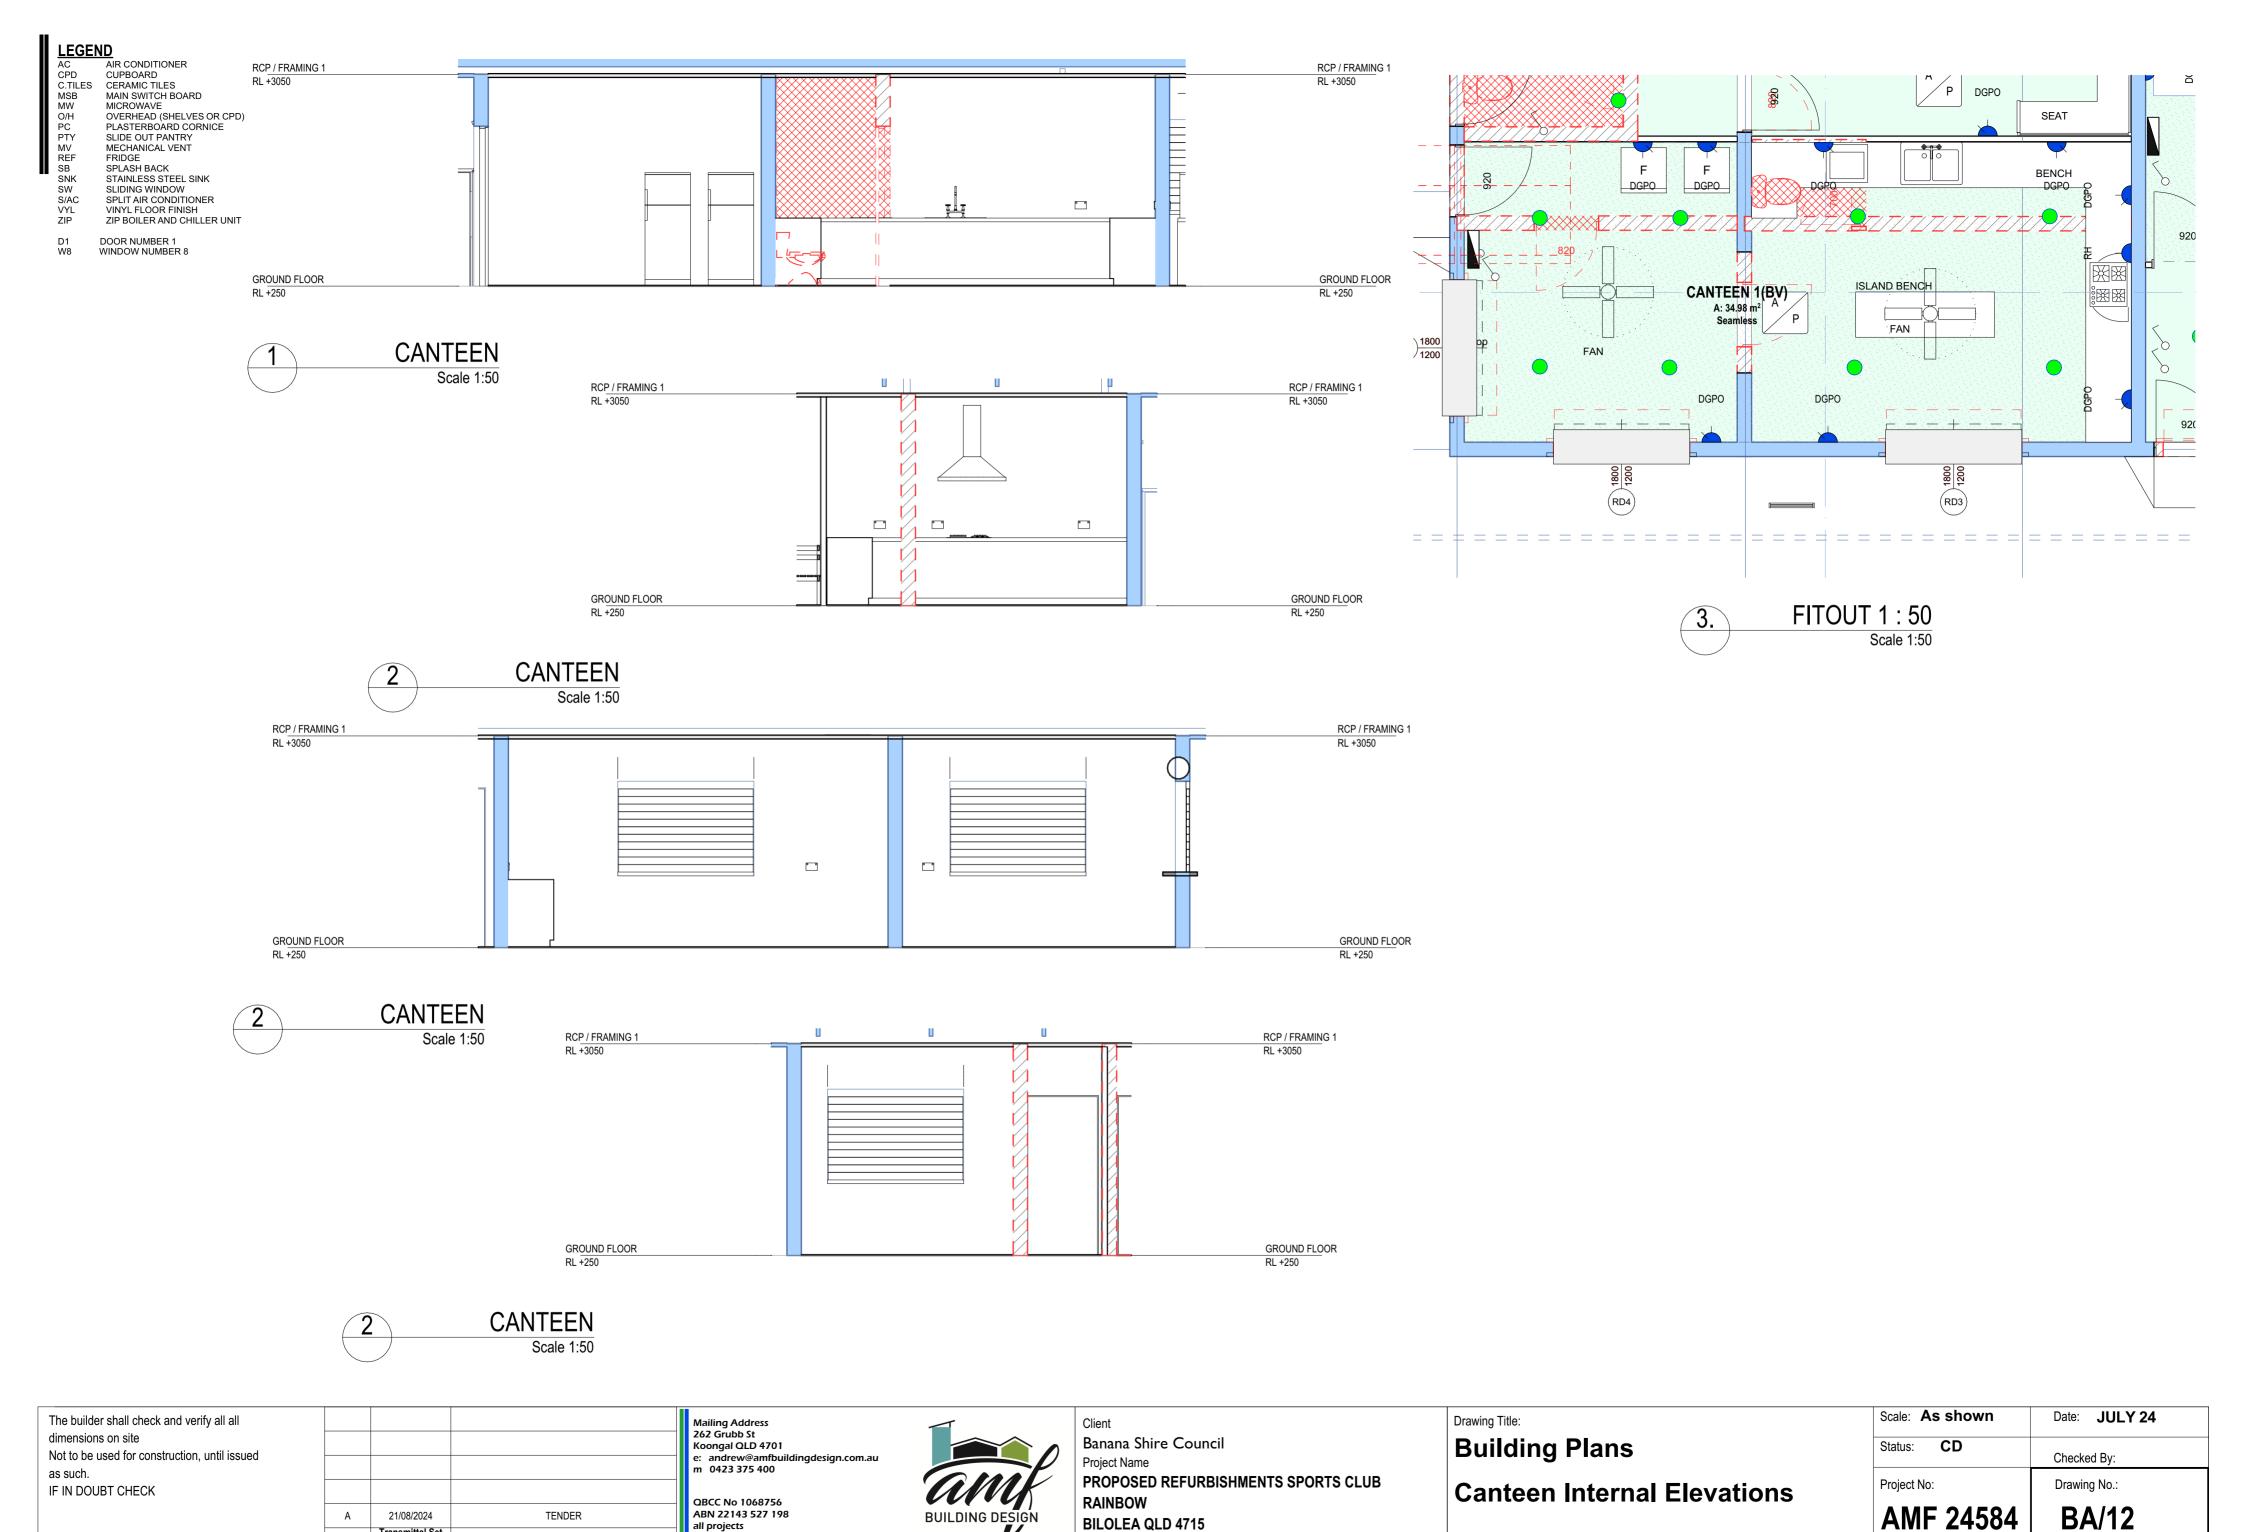



BILOLEA QLD 4715

all projects residential,commercial,industrial

Transmittal Set

DESCRIPTION

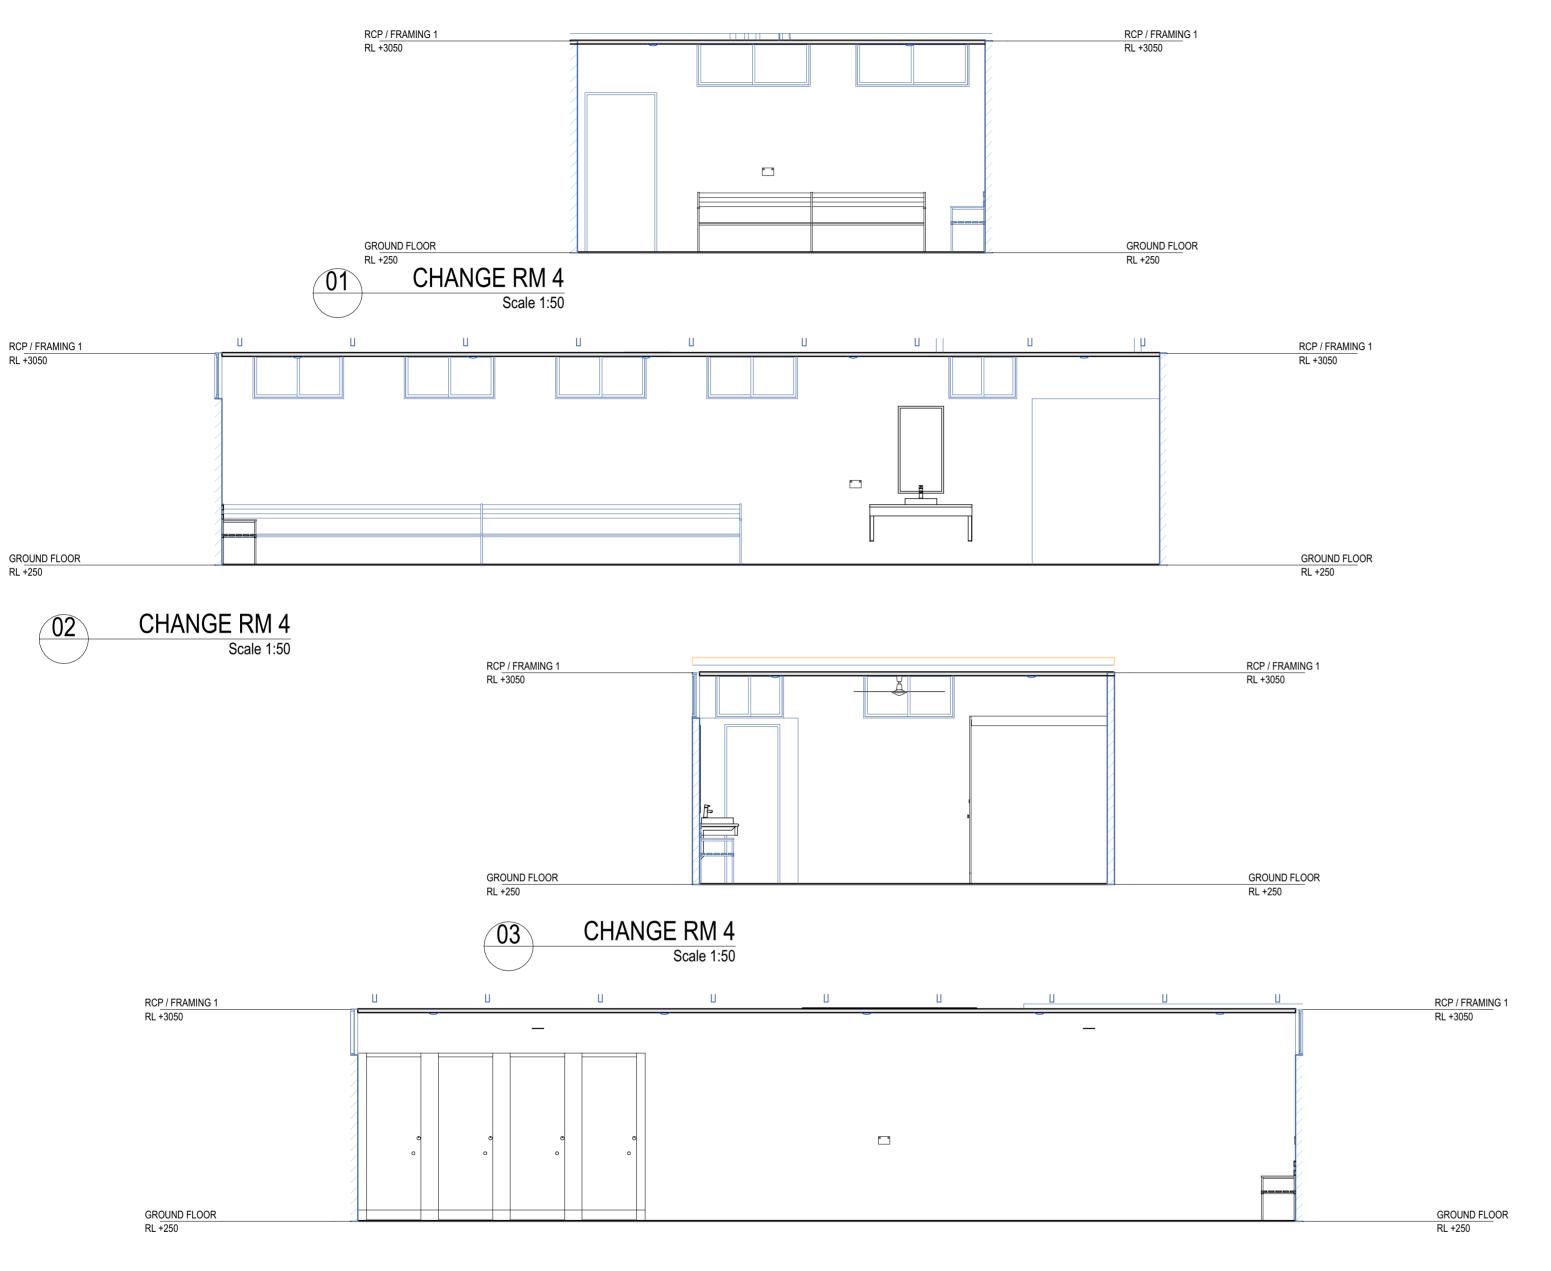

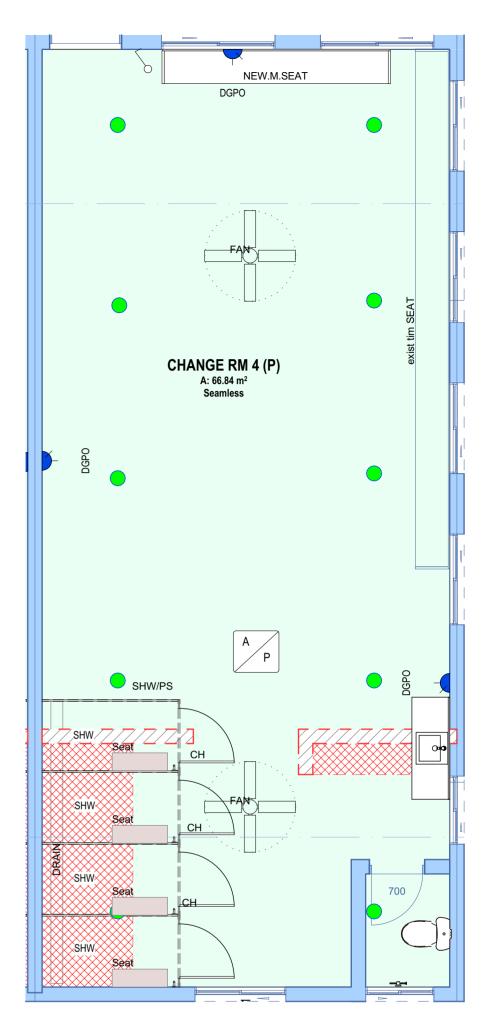

3. FITOUT 1 : 50
Scale 1:50

O4 CHANGE RM 4
Scale 1:50

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Mailing Address
262 Grubb St
Koongal QLD 4701
e: andrew@amfbuildingdesign.com.au
m 0423 375 400

QBCC No 1068756

TENDER

DESCRIPTION

ABN 22143 527 198

all projects residential,commercial,industrial



Client
Banana Shire Council
Project Name
PROPOSED REFURBISHMENTS SPORTS CLUB
RAINBOW
BILOLEA QLD 4715

Building Plans
CHANGE ROOMS

Scale: As shown

Status: CD

Checked By:

Project No: Drawing No.:

AMF 24584

BA/13

REV ID

21/08/2024

Transmittal Set